SUBSTITUTIONS TO THE PLANS ARE THE COORDINATE W/ THE RELEASED DOCUMENTS.

3. ENERGY CALCULATIONS SHALL BE CONDUCTED 26. ALL MATERIALS SHALL BE NEW UNLESS CONDITIONS. BY A THIRD PARTY RECOGNIZED BY THE GOVERNING OTHERWISE NOTED. BODY TO DO SUCH SERVICES.

5. FOUNDATION SHALL ADHERE TO DESIGN DESIGN REQUIREMENT OR INTENT. WHERE A SPECIFIC 4. THE CONTRACTOR SHALL CONSULT WITH ROOMS. PROVIDED BY STRUCTURAL ENGINEER. STRUCTURAL
PRODUCT IS SPECIFIED, NO SUBSTITUTIONS OR STRUCTURAL ENGINEER BEFORE DEMOLITION OF ANY 7. METAL, VINYL, OR ADHESIVE FLASHING SHALL BE DRAWINGS INCLUDED IN THIS SET TO ONLY INDICATE ALTERNATES WILL BE ALLOWED WITHOUT PRIOR STRUCTURAL MEMBERS. THE CONTRACTOR SHALL INSTALLED AT HORIZONTAL WOOD TRIM, OPENINGS, THE DIMENSIONAL GUIDELINES TO LAYOUT THE APPROVAL OF THE DESIGNER. FOUNDATION AND SHOULD BE COORDINATED W/ ARCHITECTURAL SET.

6. HEATING AND COOLING SYSTEM SHALL BE DESIGNED BY INSTALLER. SUPPLY AND RETURN VENTS DESIGNED BY INSTALLER. SUPPLY AND RETURN VENTS
SHALL ALIGN WITH LIGHT OR CENTER ON WALLS AND
COST REDUCTION (i.e.: VALUE ENGINEERING) OF A FROM DAMAGE DUE TO CONSTRUCTION AND
CABINETRY NOTES AVOID CONFLICT WITH FURNISHINGS & TRIM.

7. DO NOT SCALE THE DRAWINGS. CONTACT THE ARCHITECT TO VERIFY ANY DIMENSIONS THAT ARE NOT INDICATED.

8. ALL CONSTRUCTION TO COMPLY WITH JURISDICTION OVER THE PROJECT.

9. CONTRACTOR SHALL USE HIS BEST EFFORTS, SKILLS. JUDGEMENT. AND ABILITIES WITH RESPECT TO THE CONSTRUCTION OF THE PROJECT, AND FURTHER THE INTERESTS OF THE OWNER IN ACCORDANCE WITH ACCEPTABLE METHODS OF CONSTRUCTION. CONTRACTOR SHALL BE SOLELY RESPONSIBLE FOR CONSTRUCTION MEANS, METHODS, TECHNIQUES, CURRENT CITY CODES SEQUENCES, AND PROCEDURES REQUIRED FOR SAFE EXECUTION AND COMPLETION OF THE WORK.

10. THE CONTRACTOR SHALL BE RESPONSIBLE FOR 2015 INTERNATIONAL MECHANICAL CODE W/ AMD. VERIFYING THE FINISHED BUILDING MEETS OR 2014 NATIONAL ELECTRICAL CODE W/ AMD. EXCEEDS ALL REQUIREMENTS OF THE 2015 IECC, AND 2015 INTERNATIONAL RESIDENTIAL CODE W/ AMD. SHALL BE RESPONSIBLE FOR COMPLETING ASSOCIATED 2015 INTERNATIONAL RESIDENTIAL EXISTING CODE SUBMITTALS TO THE AUTHORITY HAVING 2015 INTERNATIONAL ENERGY CONSERVATION CODE TO MECHANICAL, ELECTRICAL, PLUMBING, AND AS REQUIRED. COLOR MATCH CAULK, UNO. JURISDICTION. SHOULD THE FINISHED BUILDING FAIL W/ AMD. TO MEET ANY OF THE REQUIREMENTS OF THE 2015 2015 INTERNATIONAL FUEL AND GAS CODE W/ AMD. INFORMATION. IECC, THE CONTRACTOR SHALL BE RESPONSIBLE FOR CORDECTING AND DESCRIPTION OF THE CONTRACTOR SHALL BE RESPONSIBLE FOR CORDECTING AND DESCRIPTION OF THE CONTRACTOR SHALL BE RESPONSIBLE FOR CORDECTING AND DESCRIPTION OF THE CONTRACTOR SHALL BE RESPONSIBLE FOR CORDECTING AND DESCRIPTION OF THE CONTRACTOR SHALL BE RESPONSIBLE FOR CORDECTING AND DESCRIPTION OF THE CONTRACTOR SHALL BE RESPONSIBLE FOR CORDECTING AND DESCRIPTION OF THE CONTRACTOR SHALL BE RESPONSIBLE FOR CORDECTING AND DESCRIPTION OF THE CONTRACTOR SHALL BE RESPONSIBLE FOR CORDECTING AND DESCRIPTION OF THE CONTRACTOR SHALL BE RESPONSIBLE FOR CORDECTING AND DESCRIPTION OF THE CONTRACTOR SHALL BE RESPONSIBLE FOR CORDECTING AND DESCRIPTION OF THE CONTRACTOR SHALL BE RESPONSIBLE FOR CORDECTING AND DESCRIPTION OF THE CONTRACTOR SHALL BE RESPONSIBLE FOR CORDECTING AND DESCRIPTION OF THE CORDECTING AND DESCRIPTION OF THE CORDECTION CORRECTING ANY DEFICIENCIES AND RESUBMITTING W/AMD. FOR JURISDICTIONAL REVIEW/ ACCEPTANCE.

11. ANY ERRORS, OMISSIONS, AND INCONSISTENCIES IN DRAWINGS, OR AMBIGUITIES BETWEEN DRAWINGS

REQUIREMENTS AND SITE CONSTRUCTION CONDITIONS, SHALL BE BROUGHT TO THE ATTENTION OF THE ARCHITECT (NTCOG AMENDED) AND THE ARCHITECT IN SUCH AN EVENT WILL CONSTITUTE ACCEPTANCE OF ANY RESULTING INSULATION (MIN., OBLIGATIONS OR RESPONSIBILITIES WITH REGARD TO ATTIC: R-36 DELAYS, COST, AND LEGAL REMEDIES RESULTING FROM NO ATTIC: R-30 THIS OR RELATED WORK.

12. CIVIL, STRUCTURAL, MECHANICAL, & LANDSCAPE 2X6 WALLS: R-19 DRAWINGS ARE PROVIDED BY THE OWNER, OR UNDERFLOOR OVER UNCONDITIONED SPACE: R-19 OTHERS AS AUTHORIZED BY THE OWNER

OBTAINING AN ACCURATE SURVEY OF THE SKYLIGHTS: U-FACTOR 0.55, 0.25 SHGC PRIOR TO THE POURING OF CONCRETE, WHICH MECHANICAL SYSTEMS (MIN.) CERTIFIES THAT THE STRUCTURE IS WITHIN THE 14 SEER ALLOWABLE BUILDING AREA FOR THE PROJECT. SUPPLY DUCTS IN UNCONDITIONED SPACE: R-6 PROVIDE ONE COPY EACH TO OWNER & ARCHITECT. RETURN DUCTS IN UNCONDITIONED SPACE: R-6

14. EXACT SIZE AND REINFORCEMENT OF ALL HOT WATER PIPING: R-3 CONCRETE WORK SHALL BE ACCORDING TO RECOMMENDATIONS FROM THE ENGINEERED SOILS LIGHT PRACTICES OF CONSTRUCTION.

15. CONTRACTOR SHALL VERIFY WITH OWNER ALL INTERIOR AND EXTERIOR FINISHES PRIOR TO FRAMING NOTES PURCHASING AND INSTALLATION.

SHALL COMPLY WITH LOCAL CODES.

FOOD OR DRINK SHALL BE ALLOWED IN BUILDING.

18. KEEP DIRT TO A MINIMUM - WALK OFF MATS CURRENT BUILDING CODE. 18. KEEP DIRT TO A MINIMUM - WALK OFF MATS CONNECTION DOLLDING CODE.

SHALL BE PROVIDED AT ENTRANCES - MATS SHALL BE 2. ALL FRAMING SHALL CONFORM TO ALL FOUNDATION PLUMBING LAYOUT. ROUGH-IN FOR GOVERNMENT CODES AND REGULATIONS.

BE IN CONTROL OF THE PROJECT SITE AND SOLELY CONFORM TO THE NATIONAL DESIGN SPECIFICATION 3. WINDOWS NOTED ON PLANS NEED TO BE 10. VERIFY RANGE VENT POWER REQUIREMENTS RESPONSIBLE FOR CONSTRUCTION MEANS AND FOR WOOD CONSTRUCTION BY THE NFPA, THE VERIFIED BY FRAMER BEFORE FRAMING TO MAKE SURE WITH THE SUPPLIER. METHODS, SCHEDULING, SEQUENCING, JOBSITE PLYWOOD DESIGN SPECIFICATION BY THE APA AND WINDOWS ORDERED, AND CURRENT MANUFACTURERS 11. ALL EXTERIOR CONVENIENCE OUTLETS TO BE SAFETY. AND COMPLIANCE WITH CONTRACT SHALL MEET THE REQUIREMENTS OF THE IRC. ALL DIMENSIONS ARE ACCURATELY NOTED. DOCUMENTS AND BUILDING OFFICIAL DIRECTIONS.

WOOD CONNECTIONS SHALL BE IN ACCORDANCE

4. WINDOWS SPECIFIED NEED TO BE CHECKED BY

12. ALL RECEPTACLES IN ALL BEDROOMS TO BE AFCI

T: TBD ACCORDINGLY, ALL CONTRACTORS AND WITH THE FASTENING SCHEDULE OF THE IRC. SUBCONTRACTORS ARE REQUIRED TO DEFEND, 4. ALL FRAMING LUMBER SHALL BE NO.2 OR DIMENSIONS EGRESS REQUIREMENTS IN ALL SLEEPING 13. PLAN LAYOUT IS A GENERAL SUGGESTION INDEMNIFY, AND HOLD HARMLESS OWNER AND BETTER SOUTHERN PINE. ALL STUD WALLS AND ROOMS. ARCHITECT FROM ANY AND ALL CLAIMS, LOSSES, SUITS, PARTITIONS ARE 2X6 @ 16" O.C. UNLESS OTHERWISE 5. WOOD STUD WALLS 2X4'S @ 16" O.C. TO ARCHITECT/DESIGNER. DAMAGES, AND LIABILITIES, INCLUDING ATTORNEYS' NOTED (REF. ENGINEER DWGS.). ALL PLUMBING WALLS AND COSTS ADISING IN ANY WAY FROM SUCH APE 274 @ 14" O.C. PLOCK ALL STUD WALLS AT AID.

SEES AND COSTS ADISING IN ANY WAY FROM SUCH APE 274 @ 14" O.C. PLOCK ALL STUD WALLS AT AID.

MAXIMUM HEIGHT OF 11 OR 12 FEET SUPPORTING 14. ALL SCONCES TO BE PLACED AT 68" AFF UNLESS.

DRAWING ABBREVIATIONS FEES AND COSTS, ARISING IN ANY WAY FROM SUCH ARE 2X6 @ 16" O.C. BLOCK ALL STUD WALLS AT MID ONE FLOOR, ROOF, AND CEILING. WALL HEIGHTS NOTED OTHERWISE. CONTRACTORS' OR SUBCONTRACTORS' SERVICES OR HEIGHT. WORK PRODUCT, EXCEPT TO THE EXTENT CAUSED BY

5. ALL LUMBER IN CONTACT WITH CONCRETE OR
TO DETERMINE STUD SIZE AND SPACING. ALL FLOOR
OWNER/ARCHITECT/DESIGNER. ARCHITECT'S SOLE NEGLIGENCE. IN SUPPORT OF THIS MASONRY SHALL BE TREATED. RAMSET BOTTOM PLATE PLAN ANGLES ARE 90 OR 45 DEGREES UNLESS 16. CENTER HANGING FIXTURES IN THE SPACE, OBLIGATION, CONTRACTORS AND SUBCONTRACTORS OF STUD WALLS TO CONCRETE WITH 1/4" RAMSETS @ OTHERWISE NOTED. EXTERIOR WALLS, WALLS WITH UNLESS NOTED OTHERWISE SHALL INCLUDE OWNER AND ARCHITECT AS 16" O.C., EXTERIOR BASE PLATES SHALL BE ADDITIONAL INSURED UNDER ITS INSURANCE POLICIES ANCHORED @ 24" O.C. W/ MIN 1/2 X 10", MIN SHALL BE 2X6 STUDS. APPLICABLE TO THE PROJECT. ARCHITECT SHALL NOT EMBEDMENT OF 8", ANCHOR BOLTS USING 3"X3" 6. VENT CLOTHES DRYER AND ALL KITCHEN & WITH BUILDER/OWNER BEFORE PULLING WIRE FOR BE RESPONSIBLE FOR DAMAGES, LOSSES, COSTS, OR WASHER. ONE ANCHOR BOLT SHALL BE WITHIN 6" TO BATHROOM EXHAUST FANS TO OUTSIDE. CLAIMS CAUSED BY CONTRACTORS OR 12" OF EACH PLATE AND WITHIN 12" OF ALL CORNERS. 7. CLEAN INSIDE ALL WALLS @ BASE TRACK W/ 18. CONTRACTOR SHALL SIZE ELECTRICAL SYSTEM SUBCONTRACTORS, EXCEPT ONLY TO THE EXTENT PROVIDE HOLD DOWN ANCHORS @ ENDS OF ALL VACUUM PRIOR TO CLOSING WALLS CAUSED BY ARCHITECT'S SOLE NEGLIGENCE.

PROVIDED BY OWNER OR OWNER'S CONSULTANTS. TO FRAMING BELOW. SOLELY FOR INTERFACE WITH ITS SERVICES AND SHALL CONNECTED WITH WALL STUDS BELOW. BRACE GABLE FINISH IS VISIBLE. STAINED WOOD FINISH FLOORING NOTIFY OWNER OF ANY ERRORS ACTUALLY IDENTIFIED ENDS AGAINST LATERAL LOADS. IN SUCH INFORMATION. ARCHITECT SHALL NOT BE 8. PROVIDE APA RATED 4'X8'X1/2" PLYWOOD WIND 10. ALL GWB SHALL BE 5/8" THICK UNO. RESPONSIBLE FOR THE ACTS OR OMISSIONS OF THE BRACING ON ALL EXTERIOR WALLS FROM SLAB TO

11. JOINTS ABUTTING EXISTING WALLS ARE TO BE OWNER, CONTRACTORS, OTHER CONSULTANTS AND UNDERSIDE OF RAFTERS. THEIR RESPECTIVE AGENTS OR EMPLOYEES, OR ANY 9. JOIST HANGERS SHALL BE 16 GA., TYPE "U" AS 12. CONTRACTOR SHALL PROVIDE BLOCKING AS OTHER PERSONS OR ENTITIES PERFORMING WORK ON MANUFACTURED BY SIMPSON STRONG TIES CO OR REQUIRED FOR ALL MILLWORK AND EQUIPMENT CONTROL OR AUTHORITY OF ARCHITECT.

21. ALL GENERAL CONDITIONS, SPECIAL BEAMS AT THE SAME ELEVATION. JOIST HANGERS REQUIREMENTS OR GENERAL REQUIREMENTS OF THE SHALL BE SAME SIZE AS THE MEMBER SUPPORTED. MANUFACTURERS SHALL APPLY AND BE ADHERED TO. 48/24, 3/4" THICK TONGUE & GROOVE.

22. ALL WORK SHALL BE IN ACCORDANCE WITH AT UNSUPPORTED EDGES BETWEEN ROOF RAFTERS. INDUSTRY STANDARDS. INDUSTRY STANDARDS SHALL NAILS TO BE EITHER 8D COMMON OR 10D BOX NAILS. ROOF PLAN NOTES BE AS DETERMINED BY MANUAL OR HANDBOOK OF MAXIMIZE SPACING FOR SHEATHING NAILING THE PRIMARY ASSOCIATION OF EACH TRADE. THE O.C. WITHIN 4' OF EXTERIOR WALLS, RIDGES OR HIPS 1. PROTECT EXISTING ROOFS FOR DURATION OF MANUALS SHALL INCLUDE, BUT NOT BE LIMITED TO: TO 6 AT SHEATHING EDGES AT EACH RAFTER. GYPSUM ASSOCIATION

APA - ENGINEERED WOOD ASSOCIATION NATIONAL THE CONTRACTORS ASSOCIATION STEEL STUD MANUFACTURERS ASSOCIATION WESTERN WOOD TRUSS ASSOCIATION CONCRETE BLOCK ASSOCIATION

RESPONSIBILITY OF THE CONTRACTOR.

25. CONTRACTOR SHALL SCHEDULE AND DEMOLITION NOTES 2. CONTRACTOR/OWNER ALTERATIONS OR COORDINATE ALL INSPECTIONS. DESIGNER AND OWNER SHALL BE NOTIFIED IN ADVANCE OF 1. RESPONSIBILITY OF THE CONTRACTOR//OWNER TO INSPECTIONS TO ENABLE THE DESIGNER AND OWNER IDENTIFY THE GENERAL NATURE OF DEMOLITION 3. ALL STOREFRONT MULLIONS ARE 2" NOMINAL TO BE PRESENT IF DESIRED.

27. IT IS THE INTENT OF THE ARCHITECT TO PROVIDE CONSTRUCTION. 4. ENERGY TESTING SHALL BE CONDUCTED BY A FLEXIBILITY TO THE OWNER IN THE SELECTION OF 3. THE CONTRACTOR SHALL INFORM ARCHITECT DIMENSIONS ARE ACCURATELY NOTED. THIRD PARTY RECOGNIZED BY THE GOVERNING BODY FIXTURES AND FINISHES. ARCHITECT DOES NOT OF ANY DISCREPANCIES ASSOCIATED WITH 6. WINDOWS SPECIFIED NEED TO BE CHECKED BY FIXTURES UNLESS SUCH PRODUCT HAS A SPECIFIC CONSTRUCTION.

> 28. VALUE ENGINEERING MAY TAKE PLACE ONLY CONSTRUCTION. AFTER AN AWARD OR CONTRACT.

CEILING AREAS. THERMOSTATS SHALL BE LOCATED PROJECT, SUCH PROPOSALS SHALL INCLUDE THE COST DEMOLITION. THE CONTRACTOR SHALL BE CENTRALLY 10" FROM JAMB OF ADJACENT DOOR TO OF REVISIONS REQUIRED BY THE DESIGN AND/OR RESPONSIBLE FOR REPLACING/REPAIRING ANY ENGINEERS. THE FEES INCURRED BY THE DESIGNER DAMAGED FINISHES, DOORS, FRAMES, AND WINDOWS AND/OR ENGINEER SHALL BE PAID FOR BY THE TO MATCH EXISTING.

30. WHEN VALUE ENGINEERING ANY PROJECT OR AND FINISH. DOCUMENT EACH COMPONENT COST IN A SCHEDULE REMOVED TO FACE OF STUD. APPLICABLE BUILDING CODES AND REGULATED
THAT IS PROVIDED TO THE OWNER FOR REVIEW. THE 8. THE CONTRACTOR SHALL PROTECT ALL AMENDMENTS AND ANY OTHER LAWS, ORDINANCES, SCHEDULE SHALL SHOW THE COST OF CONSTRUCTION INTERIOR SPACES FROM DAMAGE DUE TO WEATHER. REGULATIONS, OR ANY OTHER BODY HAVING PRIOR TO AND AFTER VALUE ENGINEERING AND SHALL THE CONTRACTOR SHALL BE RESPONSIBLE FOR INCLUDE ADDITIONS AND REDUCTIONS OF BOTH REPLACING/REPAIRING ANY DAMAGE DUE TO MATERIALS AND LABOR FOR EACH ITEM.

> 1. THE VALUE ENGINEERING SCHEDULE SHALL ANY FURNISHINGS DURING CONSTRUCTION. INCLUDE ALL TRADES AFFECTED.

TO BE PROTECTED FROM DAMAGE AT ALL TIMES.

2015 INTERNATIONAL BUILDING CODE W/ AMD. 2015 INTERNATIONAL PLUMBING CODE W/ AMD.

2X4 WALLS: R-13+3 (R-13 CAVITY + R+3 INSULATING SHEATHING)

13. CONTRACTOR SHALL BE RESPONSIBLE FOR WINDOWS & GLASS DOORS: U-FACTOR 0.35, SHGC 0.25

REFRIGERANT PIPING: R-3

REPORT (PROVIDED BY THE OWNER), AND ACCEPTABLE

75% OF THE PERMANENTLY INSTALLED LIGHT FIXTURES

ALL WIRES AND CONDUIT NOT COMPLETELY REMOVED TO HAVE HIGH EFFICIENCY LAMPS (CFL OR LED)

1. UTILIZATION OF FOLLOWING CHECKLIST DOES FLOOR PLAN NOTES 16. ATTIC AND CRAWLSPACE (IF ANY) VENTILATION NOT RELIEVE THE CONTRACTOR OF MEETING ALL OF REQUIREMENTS OF THE LAW. IT IS INCUMBENT ON 1. PLAN DIMENSIONS ARE TO CENTER LINE OF NOTED OTHERWISE. ANYONE PERFORMING RESIDENTIAL CONSTRUCTION STUD OR EXTERIOR FACE OF BRICK/FOUNDATION. 17. ONCE BUILDING IS ENCLOSED WITH FINISHES, NO TO FAMILIARIZE THEMSELVES WITH ALL APPLICABLE ASPECTS OF THE CURRENT BUILDING CODE TO ASSURE ARE TO CENTERLINES OF WALL AND ARE INDICATED AS BRACKET, U.N.O. THAT STRUCTURES THEY ARE BUILDING MEET THE A GUIDE TO ROUGH-IN PLUMBING. QUANTITY AND 8. SMOKE DETECTORS: 110 VOLT. COORDINATE W/ T: 972.948.8192

RESIDENTIAL CODE (IRC), 2015 EDITION. 19. THE CONTRACTOR AND SUBCONTRACTORS SHALL 3. ALL WOOD FRAMING AND ERECTION SHALL BEFORE ROUGH-IN.

SHEAR PANELS/WALLS. ALSO SEE NOTE 12. 20. ARCHITECT SHALL BE ENTITLED TO RELY ON THE BRACING SHALL BE PROVIDED PER BUILDING CODE. EXISTING PLANS. NOTIFY ARCHITECT OF ANY PROPOSED TO THE OWNER PRIOR TO PURCHASING ADEQUACY AND ACCURACY OF INFORMATION PROVIDE DOUBLE JOIST AT ALL STUD WALLS PARALLEL DISCREPANCIES. ARCHITECT SHALL COORDINATE SUCH INFORMATION 7. GABLE ENDS TO BE BUILT SIMILAR TO AND LOCATIONS WHERE NATURAL OR STAINED WOOD

THE PROJECT WHO ARE NOT UNDER THE DIRECT EQUIV. INSTALL IN STRICT ACCORDANCE WITH THE INSTALLATION. MANUFACTURER'S SPECIFICATIONS. USE JOIST HANGERS FOR JOIST AND BEAMS WHICH FRAME TO 2X6 STUDS UNLESS NOTED OTHERWISE. CONSTRUCTION SPECIFICATIONS OF MATERIAL 10. PLYWOOD SUBFLOORING SHALL BE APA RATED OPENING OF POCKET DOOR, COORDINATE W/ ARCH.

11. ROOF SHEATHING SHALL BE OSB. PROVIDE CLIPS FINISHED FACE OF CEILING. ALL OTHER SHEATHING TO BE NAILED AT 6" O.C. AT 2. CONTINUOUS FULLY-ADHERED ROOFING

SOLID BLOCKING OVER GABLE STUD TOP PLATE.

23. SHOP DRAWINGS OR DRAWINGS PROVIDED BY THE TOP OF BOTTOM EDGES OF JOIST, NOT LARGER WALL. OTHERS ARE NOT PART OF THE CONTRACT THAN 1 1/4" DIA AND NOT IN THE MIDDLE OF A SPAN. 4. ADDITIONAL STRIP OF FULLY-ADHERED DOCUMENTS BUT SHALL BE PREPARED IN 13. ALL STUDS CUT AWAY FOR PLUMBING SHALL BE ROOFING MEMBRANE TO BE APPLIED AT ALL ACCORDANCE WITH THE CONTRACT DOCUMENTS STRAPPED WITH 1 1/2" WIDE, NO. 24 GAUGE ROOF-WALL INTERSECTIONS EXTENDING MIN. 12" STANDARD PRACTICE NEED TO BE BROUGHT TO THE ACCORDANCE WITH THE CONTRACT DOCUMENTS STRAFFLD WITH 1 1/2 WIDE, 100. 27 GROOF MEMBRANE AND 12" UP FACE OF WALL OVER ROOF MEMBRANE AND 12" UP FACE OF WALL AND SPIKED TO PLATES.

REQUIREMENTS

THE NATURE OF THE DEMOLITION PLANS IS TO ADJACENT WALL COLOR. SCOPE. THE CONTRACTOR IS RESPONSIBLE FOR UNLESS NOTED OTHERWISE.

SELECT SPECIFIC MANUFACTURERS OF PRODUCTS OR DEMOLITION SCOPE OF WORK AND NEW CONTRACTOR TO BE SURE CURRENT MANUFACTURING

THE CONTRACTOR SHALL PROTECT ALL VENTING SHALL BE OUT OF SIGHT FROM FRONT & EXISTING FINISHES, DOORS, FRAMES, AND WINDOWS REAR ELEVATION IF POSSIBLE. 6. PATCH AND REPAIR ALL EXISTING CEILINGS, 3.

PART OF ANY PROJECT, THE CONTRACTOR SHALL 7. ALL WALL FINISHES TO BE REMOVED SHALL BE

9. COORDINATE WITH OWNER RELOCATION OF 10. THE CONTRACTOR IS TO MAINTAIN A SEPARATION BETWEEN AREAS WITHIN THE SCOPE OF DISCREET AND SHOULD BE CONCEALED IF POSSIBLE. THE HIGHEST PROFESSIONAL STANDARDS AND 32. ADJACENT PROPERTIES, STREETS AND WALKS ARE WORK AND AREAS OUTSIDE OF THE SCOPE OF WORK BY PROVIDING PLASTIC SHEATHING BETWEEN CONTIGUOUS SPACES AND/OR TEMPORARILY TAPING

> OF JOINTS AND GAPS TO PREVENT DUST MIGRATION. MATERIAL LEGALLY FROM THE SITE. COMPLY WITH ALL LOCAL HAULING & DISPOSAL REQUIREMENTS. 12. IT IS THE CONTRACTORS RESPONSIBILITY TO LOCATE AND REMOVE ANY MECHANICAL, ELECTRICAL, STRUCTURAL DRAWINGS FOR DEMOLITION

ALL SALVAGED ITEMS. ITEMS NOT CLAIMED BY THE OWNER BECOME THE RESPONSIBILITY OF THE QUALITY NOTES CONTRACTOR, AND SHALL BE DISPOSED OF FROM THE

SHALL NOT BE HELD LIABLE FOR ANY ASBESTOS OR TO BE LOCATED IN ATTIC. OTHER HAZARDOUS MATERIALS ON-SITE. THE 2. CONTRACTOR SHALL IMMEDIATELY ISOLATE THE 3. AFFECTED AREA IF ASBESTOS OR OTHER HAZARDOUS PRESSURE & AIR FLOW MATERIALS ARE DISCOVERED DURING CONSTRUCTION, 4. AIR FILTER HOUSING MUST BE AIRTIGHT AND NOTIFY THE OWNER AND ARCHITECT. 15. EXISTING CONSTRUCTION MAY CONTAIN 5

THOUGHT TO CONTAIN ASBESTOS MUST BE SEALED INSPECTED BY AN EPA CERTIFIED INSPECTOR CAPABLE OF SAMPLING FOR THE EXISTENCE OF ASBESTOS. SPACE WORK SHALL BE DONE IN ACCORDANCE WITH THE ADJACENT TO GARA MOST CURRENT OSHA REGULATIONS & DISPOSED OF 8. PENETRATIONS MUST SEALED IN ACCORDANCE WITH CURRENT EPA REGULATIONS. 9. DOORS MUST HAVE WEATHER STRIPPING 16. EXISTING CONSTRUCTION MAY CONTAIN LEAD 10. CRACKS AT WALL BASE MUST BE SEALED CONTAIN LEAD MUST BE INSPECTED BY AN EPA CERTIFIED INSPECTOR CAPABLE OF SAMPLING FOR 1. ELECTRICAL INSTALLATION SHALL MEET THE EXISTENCE OF LEAD. WORK SHALL BE DONE IN ACCORDANCE WITH THE MOST CURRENT OSHA REGULATIONS & DISPOSED OF IN ACCORDANCE WITH

CURRENT EPA REGULATIONS. 17. THE GENERAL CONTRACTOR SHALL REMOVE ALL UNUSED SWITCH PLATES, WIRING, AND EQUIPMENT. TO THE SOURCE MUST TERMINATE IN A JUNCTION BOX

SIZE OF PLUMBING STACKS ARE NOT DETERMINED BY ALARM SYSTEM. DETECTORS TO COMPLY WITH APPLICABLE SECTIONS OF THE INTERNATIONAL FIXTURES, SHOWERS, AND OTHER REQUIRED SLAB 9. PROVIDE 220V JUNCTION BOX AND OTHER LEAVE OUTS SHOULD BE VERIFIED BY THE PLUMBER REQUIRED WIRING FOR HVAC UNITS. VERIFY

CONTRACTOR TO BE SURE CURRENT MANUFACTURING PROTECTED.

EXCEEDING 10 FEET REQUIRE STRUCTURAL ANALYSIS 15. VERIFY ALL HANGING FIXTURE HEIGHTS W/

8. FIELD VERIFY LOCATION OF ALL EXISTING WALLS 19. ALL APPLIANCES, PLUMBING AND LIGHTING

9. VERIFY WOOD SPECIES WITH ARCHITECT IN ALL SHALL MATCH STAINED WOOD TRIM TYPICAL, U.N.O. TAPED AND FINISHED.

13. INTERIOR PARTITION WALLS ARE FRAMED WITH INSTALLATION INSTRUCTIONS TO DETERMINE ROUGH 15. CEILING HEIGHT NOTED FOR EACH ROOM IS TO

EDGES AND A 12" O.C. IN THE CENTER OF THE MEMBRANE TO BE APPLIED SHINGLE STYLE OVER SHEATHING PANELS. SHEATHING AT GABLE RAKES ENTIRE ROOF INCLUDING OVERHANGS AT EAVES AND SHALL BE NAILED AT 4" O.C. AT OUTLOOK BLOCK & AT RAKES AND OVER PORCHES AND BREEZEWAY. CONTINUOUS FULLY-ADHERED ROOFING MEMBRANE TO BE EXTENDED MIN. 12" UP/ DOWN EXTERIOR WALL SHEATHING AT ALL ROOF-WALL INTERSECTIONS

12. ALL BORED HOLES SHALL BE 2" CLEAR FROM EXCEPT WHERE PORCH OR BREEZEWAY ROOF MEETS INSUI ATION SHEATHING

ALL SIDING SHALL BE OF SMOOTH TYPE UNLESS NOTED OTHERWISE. SEALANT AT EXPANSION JOINTS SHALL MATCH

VISITING THE SITE AND VERIFYING THE EXISTING 4. ALL GLAZING IS LOW "E" UNLESS NOTED THE CONTRACTOR SHALL COORDINATE ALL 5. WINDOWS NOTED ON PLANS NEED TO BE DEMOLITION SCOPE OF WORK WITH NEW VERIFIED BY FRAMER BEFORE FRAMING TO MAKE SURE WINDOWS ORDERED, AND CURRENT MANUFACTURERS

DIMENSIONS EGRESS REQUIREMENTS IN ALL SLEEPING PROVIDE ALL TEMPORARY STRUCTURAL BRACING AND TERMINATIONS OF SIDING. EXPOSED FLASHING NECESSARY DURING DEMOLITION AND SHALL BE PAINTED TO MATCH ADJACENT TRIM.

SCRIBE ALL CABINETRY TO THE WALL & FLOORS. CONTRACTOR SHALL PROVIDE SHOP DRAWINGS FOR OWNER AND DESIGNER APPROVAL INSTALL ELECTRICAL PLUGS UNDER ALL UPPER CABINETRY IN KITCHEN AND BUTLER'S PANTRY, U.N.O. PARTITIONS, AND FLOORS DISTURBED FOR NEW WORK . A THIN VALENCE TO BE ADDED TO BOTTOM OF UPPERS WHERE OUTLETS AND/OR UNDER CABINET

8. ALL NECESSARY ROOF PENETRATIONS &

IGHTING IS SPECIFIED. ALL CABINETS SHALL HAVE A 1/8" REVEAL NO SCREEN MOLD. FIELD VERIFY ALL MEASUREMENTS BEFORE

MANUFACTURING AND INSTALLATION. PROVIDE REO'D BLOCKING FOR ALL WALL CABINET INSTALLATION PROVIDE ADDITIONAL SUPPORT AT ALL WORK SURFACES AS REQUIRED, SUPPORTS ARE TO BE ALL EXPOSED SIDES TO BE FINISHED TO MATCH

ADJACENT 10. ELECTRICAL DEVICES ARE SHOWN FOR COORDINATION PURPOSES ONLY. REF. ELECTRICAL. GENERAL DESCRIPTION OF WORK 11. DISPOSE OF ALL DEMOLISHED OR REMOVED CONTACT ARCHITECT IF CONFLICT OCCURS. RECEPTACLES SHOWN IN MILLWORK SHALL HAVE NEW SINGLE FAMILY RESIDENCE LOCATED IN THE PROPERTY @ 3025 BRYN MAWR DR. IN THE GENERAL NOTE ROUGH-INS EXTENDED SO COVER PLATE WILL MOUNT CITY OF UNIVERSITY PARK, TX 75225 (BLOCK 10, LOT 1). TO INSIDE FACE OF CABINET. 1. ALL MILLWORK SUBSTRATES AT WET LOCATIONS

13. OUTLETS PROVIDED NEAR SINKS, LAVS, ETC. ARE TO BE GFRC TYPE - REF ELECTRICAL.

14. THE ARCHITECT HAS NO KNOWLEDGE OF AND 1. HVAC SYSTEM & GAS TANKLESS WATER HEATER AIR FILTERS MUST BE MERV 8 OR GREATER AIR HANDLERS MUST BE SIZED TO MAINTAIN AIR

ABOVE THE GARAGE PENETRATIONS MUST BE SEALED ASBESTOS CONTAMINATED PRODUCTS. MATERIALS 6. FLOOR AND CEILING JOISTS BAYS MUST BE PAINTED WALLS & CEILINGS OF CONDITIONED

REQUIREMENTS OF APPROVED CITY CODES AND REGULATIONS. VERIFY UTILITIES AND LOCATIONS WITH CONTRACTOR SWITCHED CONVENIENCE OUTLETS TO BE

SWITCHED AT TOP OUTLET ONLY. SWITCHES: 4'-0" ABOVE FINISH FLOOR TO WITH COVER AND APPROPRIATE INSULATORS CENTERLINE OF SWITCH, UNLESS NOTED OTHERWISE. SUFFICIENT TO MAINTAIN COMPLIANCE WITH 5. CONVENIENCE COTLETO. 1 O ABOUT TO SUFFICIENT TO MAINTAIN COMPLIANCE WITH FLOOR TO CENTERLINE OF OUTLET UNLESS NOTED

OTHERWISE. 6. INTERIOR WALL BRACKET FIXTURES: 66" ABOVE FINISH FLOOR TO CENTERLINE OF BRACKET UNLESS 7. EXTERIOR WALL BRACKET FIXTURES: 6'-10"

2. DIMENSIONS TO ROUGH PLUMBING LOCATIONS ABOVE FINISH WALKING SURFACE TO CENTERLINE OF

LOCATIONS WITH CONTRACTOR. WATER PROOF AND ON A GROUND FAULT CIRCUIT.

EXPECTED TO BE FINALLY REVISED BY OWNER/

POCKET DOORS, AND WALLS BEHIND WATER CLOSETS 17. ELECTRICAL INSTALLER SHALL LOCATE ROUGH IN ADJ. BOXES AS INDICATED ON PLANS, WALK THE PROJECT FINAL APPROVAL LOCATIONS. TO COMPLY WITH LOCAL CODE REQUIREMENTS. 6. WOOD CROSS BRIDGING, BLOCKING, AND AS LOCATIONS MAY DIFFER FROM THOSE SHOWN ON FIXTURES NOT SPECIFIED IN THE DRAWINGS SHALL BE

UNDER ROOF W/ 5,974 SQ.FT. BEING LIVABLE AIR CONDITIONED SPACE.

LOT IS 11,200 SQ.FT.

SCOPE OF WORK CALCULATIONS 7,153 SQ.FT.

TOTAL STRUCTURE **NEW A.C. SQ.FT NEW GARAGE SQ.FT NEW PORCH SQ.FT**

TOTAL LOT SQ.FT.

PROJECT TEAM

A.F.F. above finished floor DW dishwasher

air conditioned

adjustable

aluminum

bottom of

between

board

building

cabinet

ceiling

closet

column

concrete

corridor

deep

double

down

diameter

dimension

cold water

down spout

COORD coordinate

continuous

control joints

center line

centimeter

CJ

CLG

CLO

CM

COL

CONC

CONT

CORR

DBL

DIA

DN

DT

architectural

DWG drawing

DWR drawer

ELEC electric

EQ equal

FN

FT

GFO

GL

GYP

GWB

HOR

ΗT

HW

INSUL

ELEV elevation

EQUIP equipment

ESMT estimated

floor

finish

feet

glss

high

gypsum

hose bib

handicapped

horizontal

hot water

insulation

interior

inch

freezer

F.F.E finishes, fixtures & equipment

general contractor

gypsum wallboard

ground fault interpreter

heating ventilation + air conditioning PLAS

MANOLO DESIGN STUDIO 4925 GREENVILLE AVE., STE. 350

CONTRACTOR

BLDG

DRAWING SYMBOLS

ENLARGED CALLOUT

INTERIOR VIEW TAG

EXTERIOR VIEW TAG

INTERIOR DOOR TAG

DIMENSION LINE

FINISH TAG

WALL TYPE TAG

REVISION CLOUD

RCP

REF

REQ

REV

EΜ

SD

SIM

SP

SPR

SQ

SS

STL

STO

T.O.

TEL

TV

TYP

U.C.

U.M.

U.N.O.

SQ.FT.

SCHED

SHLVS shelves

reference

required

revisions

schedule

similar

speaker

sprinkler

square

stone

steel

stone

top of

telephone

television

under counter

unless otherwise noted

under mount

typical

tile

STRUCT structure

standing

specification

solid surface

square footage

smoke detector

room

junction box

long

laminate

lavatory

meter

maximum

mechanical

minimum

millimeter

microwave

not to scale

overhead

opposite

plate

plastic

plywood

powder

quantity

radius

not in contract

not applicable

provided by owner

mirror

metal

north

miscellaneous

MANUF manufacturer

SAMPLE TEXT

X.X

(x.x) —

AND PLUMBING EQUIPMENT NECESSARY TO COMPLETE THE DEMOLITION SCOPE OF WORK. REFER 12. CAULK AT ALL COUNTERS AND BACKSPLASHES AS PROJUED OF COUNTERS AND BACKSPLASHES AS

THE RESIDENCE HAS 5 BEDROOMS, 5-1/2 BATHROOMS, A 3-CAR GARAGE, AND A POOL. THE

THIRD PARTY GREEN & ENERGY CERTIFICATES TO BE PROVIDED BY G.C. AS REQUESTED BY

5,974 SQ.FT. 857 SQ.FT

322 SQ.FT 11,200 SQ.FT

EXTERIOR DOOR TAG FIRE SPRINKLER NEEDED: YES

KEYNOTE TAG ARCHITECTURE & INTERIOR DESIGN **CEILING TAG**

DALLAS, TX 75206 T: 214.501.4984

STRUCTURAL ENGINEER NORTH ARROW JEREMY SMITH. PE

DRAWING SCALE **BUILDING SECTION DETAIL SECTION**

MR

MTL

MW

N.T.S.

O.H.

P.B.O.

PWDR

reflected ceiling plan UTIL utility V.I.F. verify in field VEST vestibule wide W.C. water closet W.H. water heater WD wood water proof WRM warming

WSCT wainscot

water resistant yard

Hanover S

VICINITY MAP

Bryn Mawr Dr

DRAWING SHEET INDEX

ARCHITECTURE

A2.1

A2.2

A3.2

A4.1

A4.2

A5.2

A6.1

E1.2

E1.3

E1.4

ID1.2

ID1.3

ID1.4

ID1.5

ID1.6

ID1.7

INTERIORS

SHEET NUMBER SHEET TITLE

TITLE SHEET

SITE PLAN

SLAB PLAN

ROOF PLAN

1ST FLOOR PLAN

2ND FLOOR PLAN

1ST FLOOR FINISH PLAN

2ND FLOOR FINISH PLAN

EXTERIOR ELEVATIONS

EXTERIOR ELEVATIONS

BUILDING SECTIONS

ENLARGED DETAILS

ENLARGED DETAILS

INTERIOR DETAILS: TYPICAL WALL TYPES & DETAILS

INTERIOR DETAILS: TYPICAL DOOR DETAILS

WINDOW & DOOR SCHEDULES

1ST FLOOR LIGHTING PLAN

2ND FLOOR LIGHTING PLAN

1ST FLOOR POWER PLAN

2ND FLOOR POWER PLAN

INTERIOR ELEVATIONS

INTERIOR ELEVATIONS

INTERIOR ELEVATIONS

INTERIOR ELEVATIONS

INTERIOR ELEVATIONS

INTERIOR ELEVATIONS

INTERIOR ELEVATIONS

INTERIOR DETAILS: TYPICAL WINDOW DETAILS

SECTION DETAILS

RIGHT-OF-WAY PLAN

ENERGY CODE COMPLIANCE

1ST FLOOR REFLECTED CEILING PLAN

2ND FLOOR REFLECTED CEILING PLAN

3025 BRYN MAWR DR UNIVERSITY PARK, TX 75225

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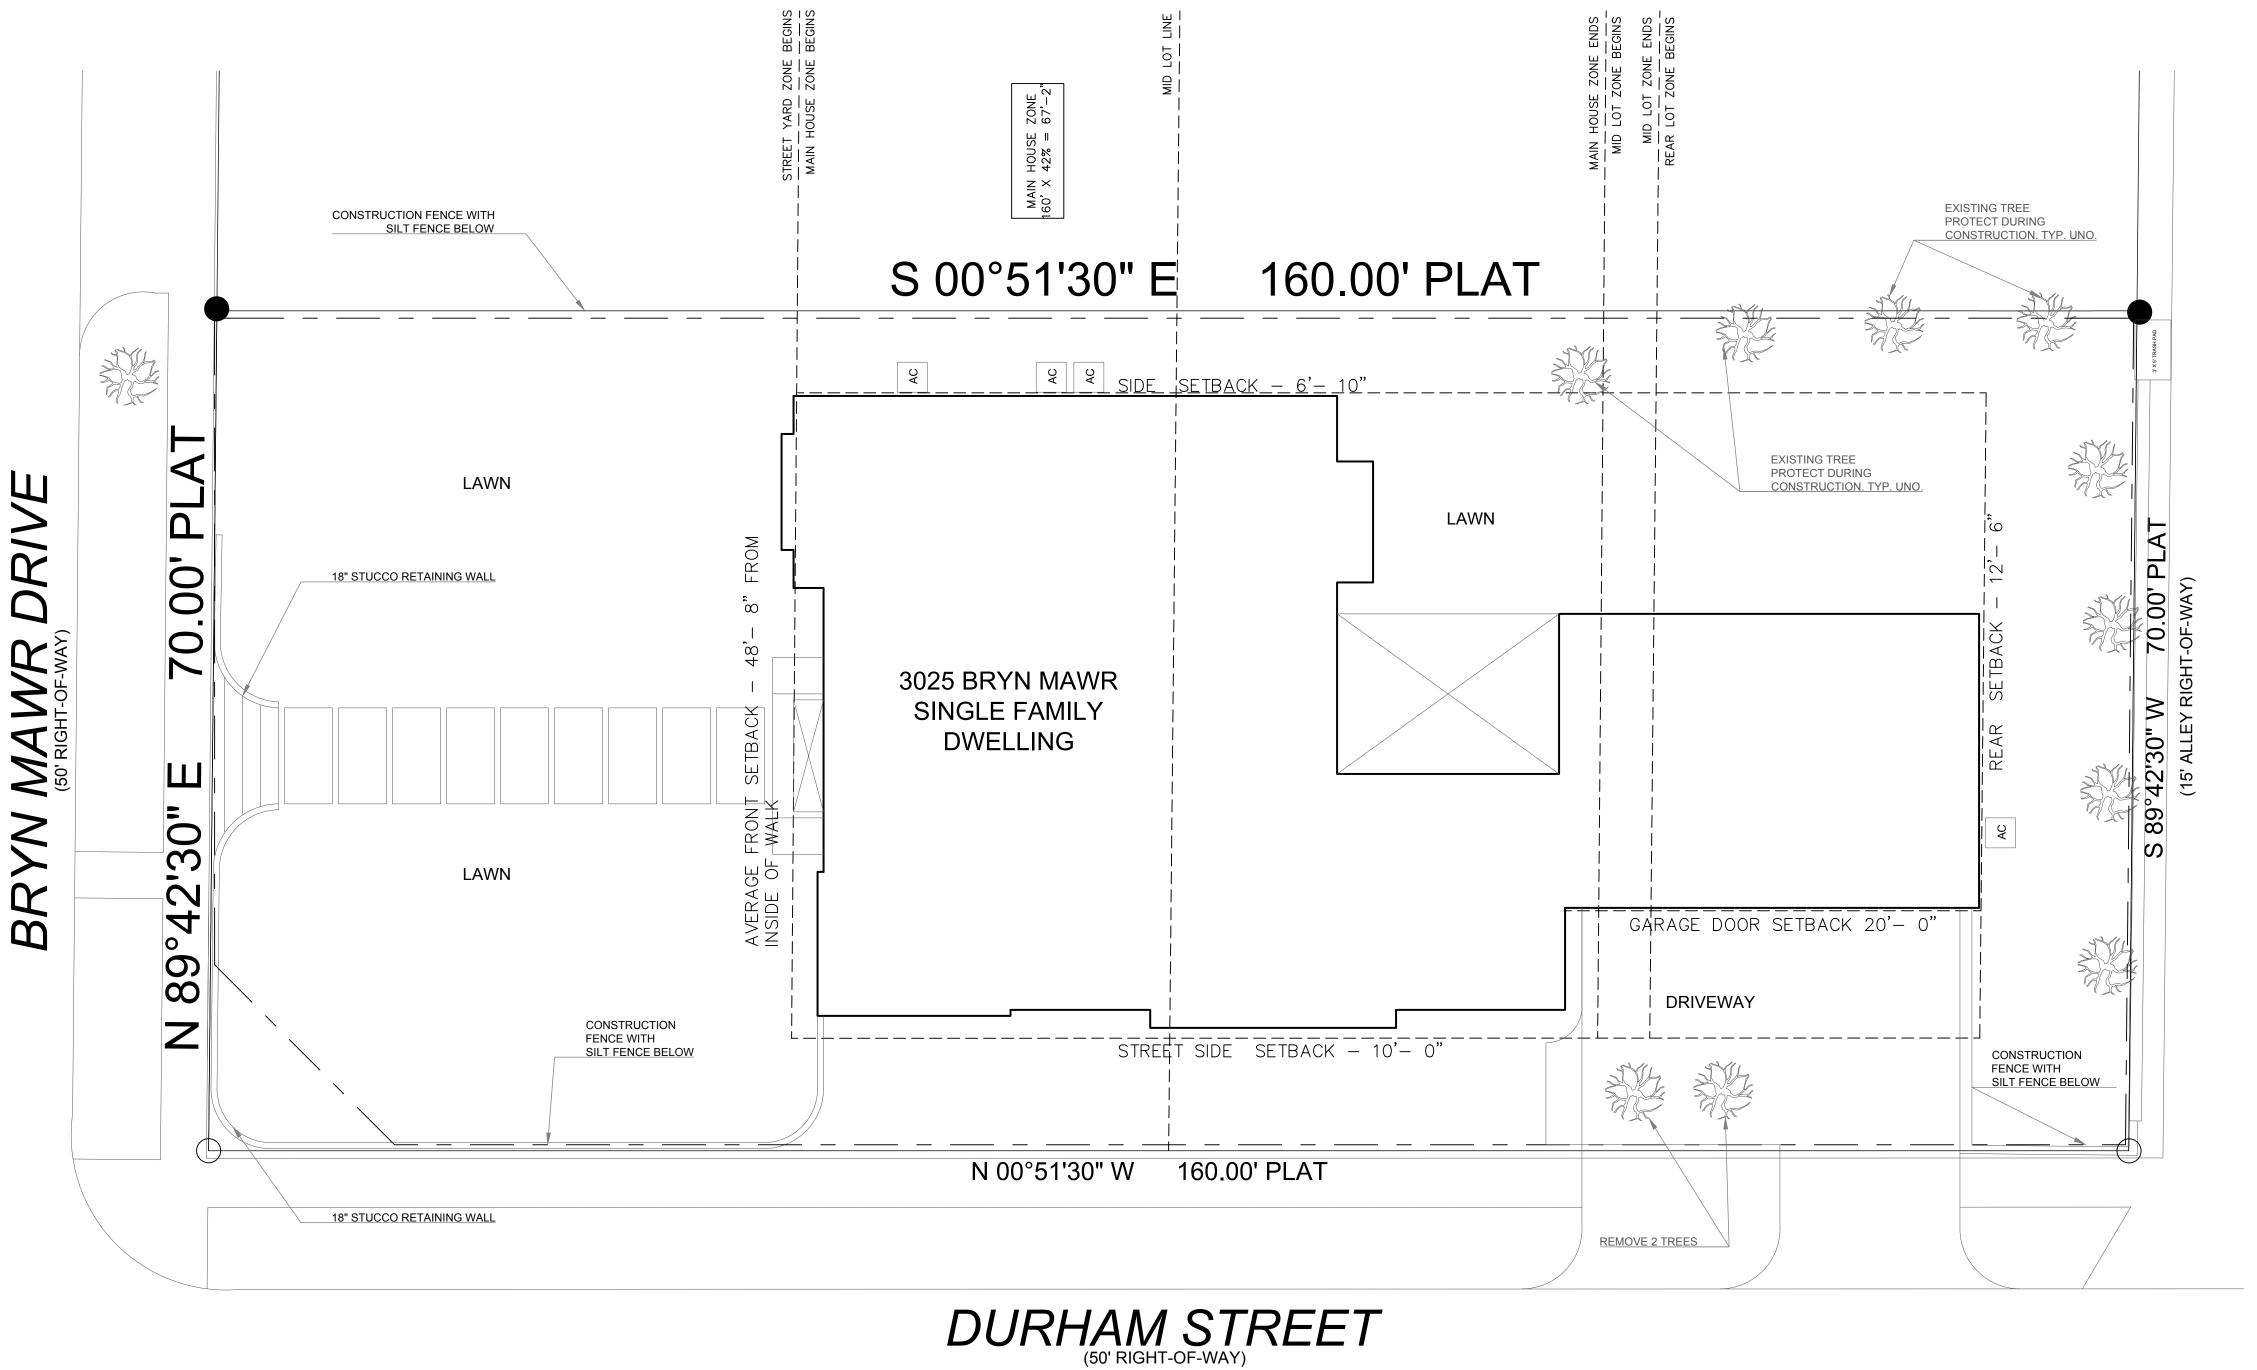
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DRAWING TITLE:

TITLE SHEET

2023.04.25



TOTAL LOT AREA	11,200 SQ
IMPERMEABLE AREAS	
HOUSE & PORCH	3,794 SC
FRONT WALKWAYS, WALL, ENTRY	468 SC
REAR DRIVEWAY	637 SC
AC PADS	25 SQ.
BAY WINDOW OVERHANG	23 SQ.
TRASH INSERT	15 SQ.
TOTAL	4,962 SC
STREET-YARD ZONE IMPERME	ABLE CALCULATION
TOTAL AREA	3,396 SQ.I
STEPS @ RETAINING WALL	67 SQ
RETAINING WALL	43 SC
PADS	288 SC
ENTRY	70 SQ
BAY WINDOW OVERHANG	23 SC
TOTAL	491 SG
CALCULATION:	404 SO FT / 2 204 SO FT = 14
MAX. ALLOWED IMPERMEABLE %:	491 SQ.FT. / 3,396 SQ.FT. = 14
BUILDING ELEMENTS ALLOWED PUR ARTICULATION PROVISIONS OF SECTION 2	SUANT TO THE FRONT FAC 24.9.
TOTAL FRONT FACADE WIDTH (100%):	
TOTAL FRONT FACADE WIDTH (100%): FRONT FACADE ARTICULATION (MAX. 60%	5
	5 OF FRONT FACADE): 16'-0" (3
FRONT FACADE ARTICULATION (MAX. 60%	5 OF FRONT FACADE): 16'-0" (3
FRONT FACADE ARTICULATION (MAX. 60% MID-LOT TO REAR-LOT BUILD	5 OF FRONT FACADE): 16'-0" (3 ING COVERAGE CALCS.
FRONT FACADE ARTICULATION (MAX. 60% MID-LOT TO REAR-LOT BUILD TOTAL AREA	OF FRONT FACADE): 16'-0" (3 ING COVERAGE CALCS. 5,601 SC
FRONT FACADE ARTICULATION (MAX. 60% MID-LOT TO REAR-LOT BUILD TOTAL AREA BUILDING COVERAGE	of FRONT FACADE): 16'-0" (3 ING COVERAGE CALCS. 5,601 SC 2,210 SC
FRONT FACADE ARTICULATION (MAX. 60% MID-LOT TO REAR-LOT BUILD TOTAL AREA BUILDING COVERAGE CALCULATION:	5 OF FRONT FACADE): 16'-0" (3 ING COVERAGE CALCS. 5,601 SC 2,210 SC 2,210 SQ.FT./ 5,601 SQ.FT. = 39.4
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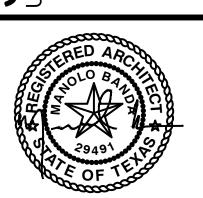
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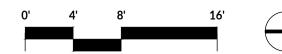
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SITE PLAN

As indicated

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ALL SXISTING SIDEWALK AND CURB/GUTTER MUST BE REPLACED PER CITY OF UNIVERSITY PARK ORDINANCE

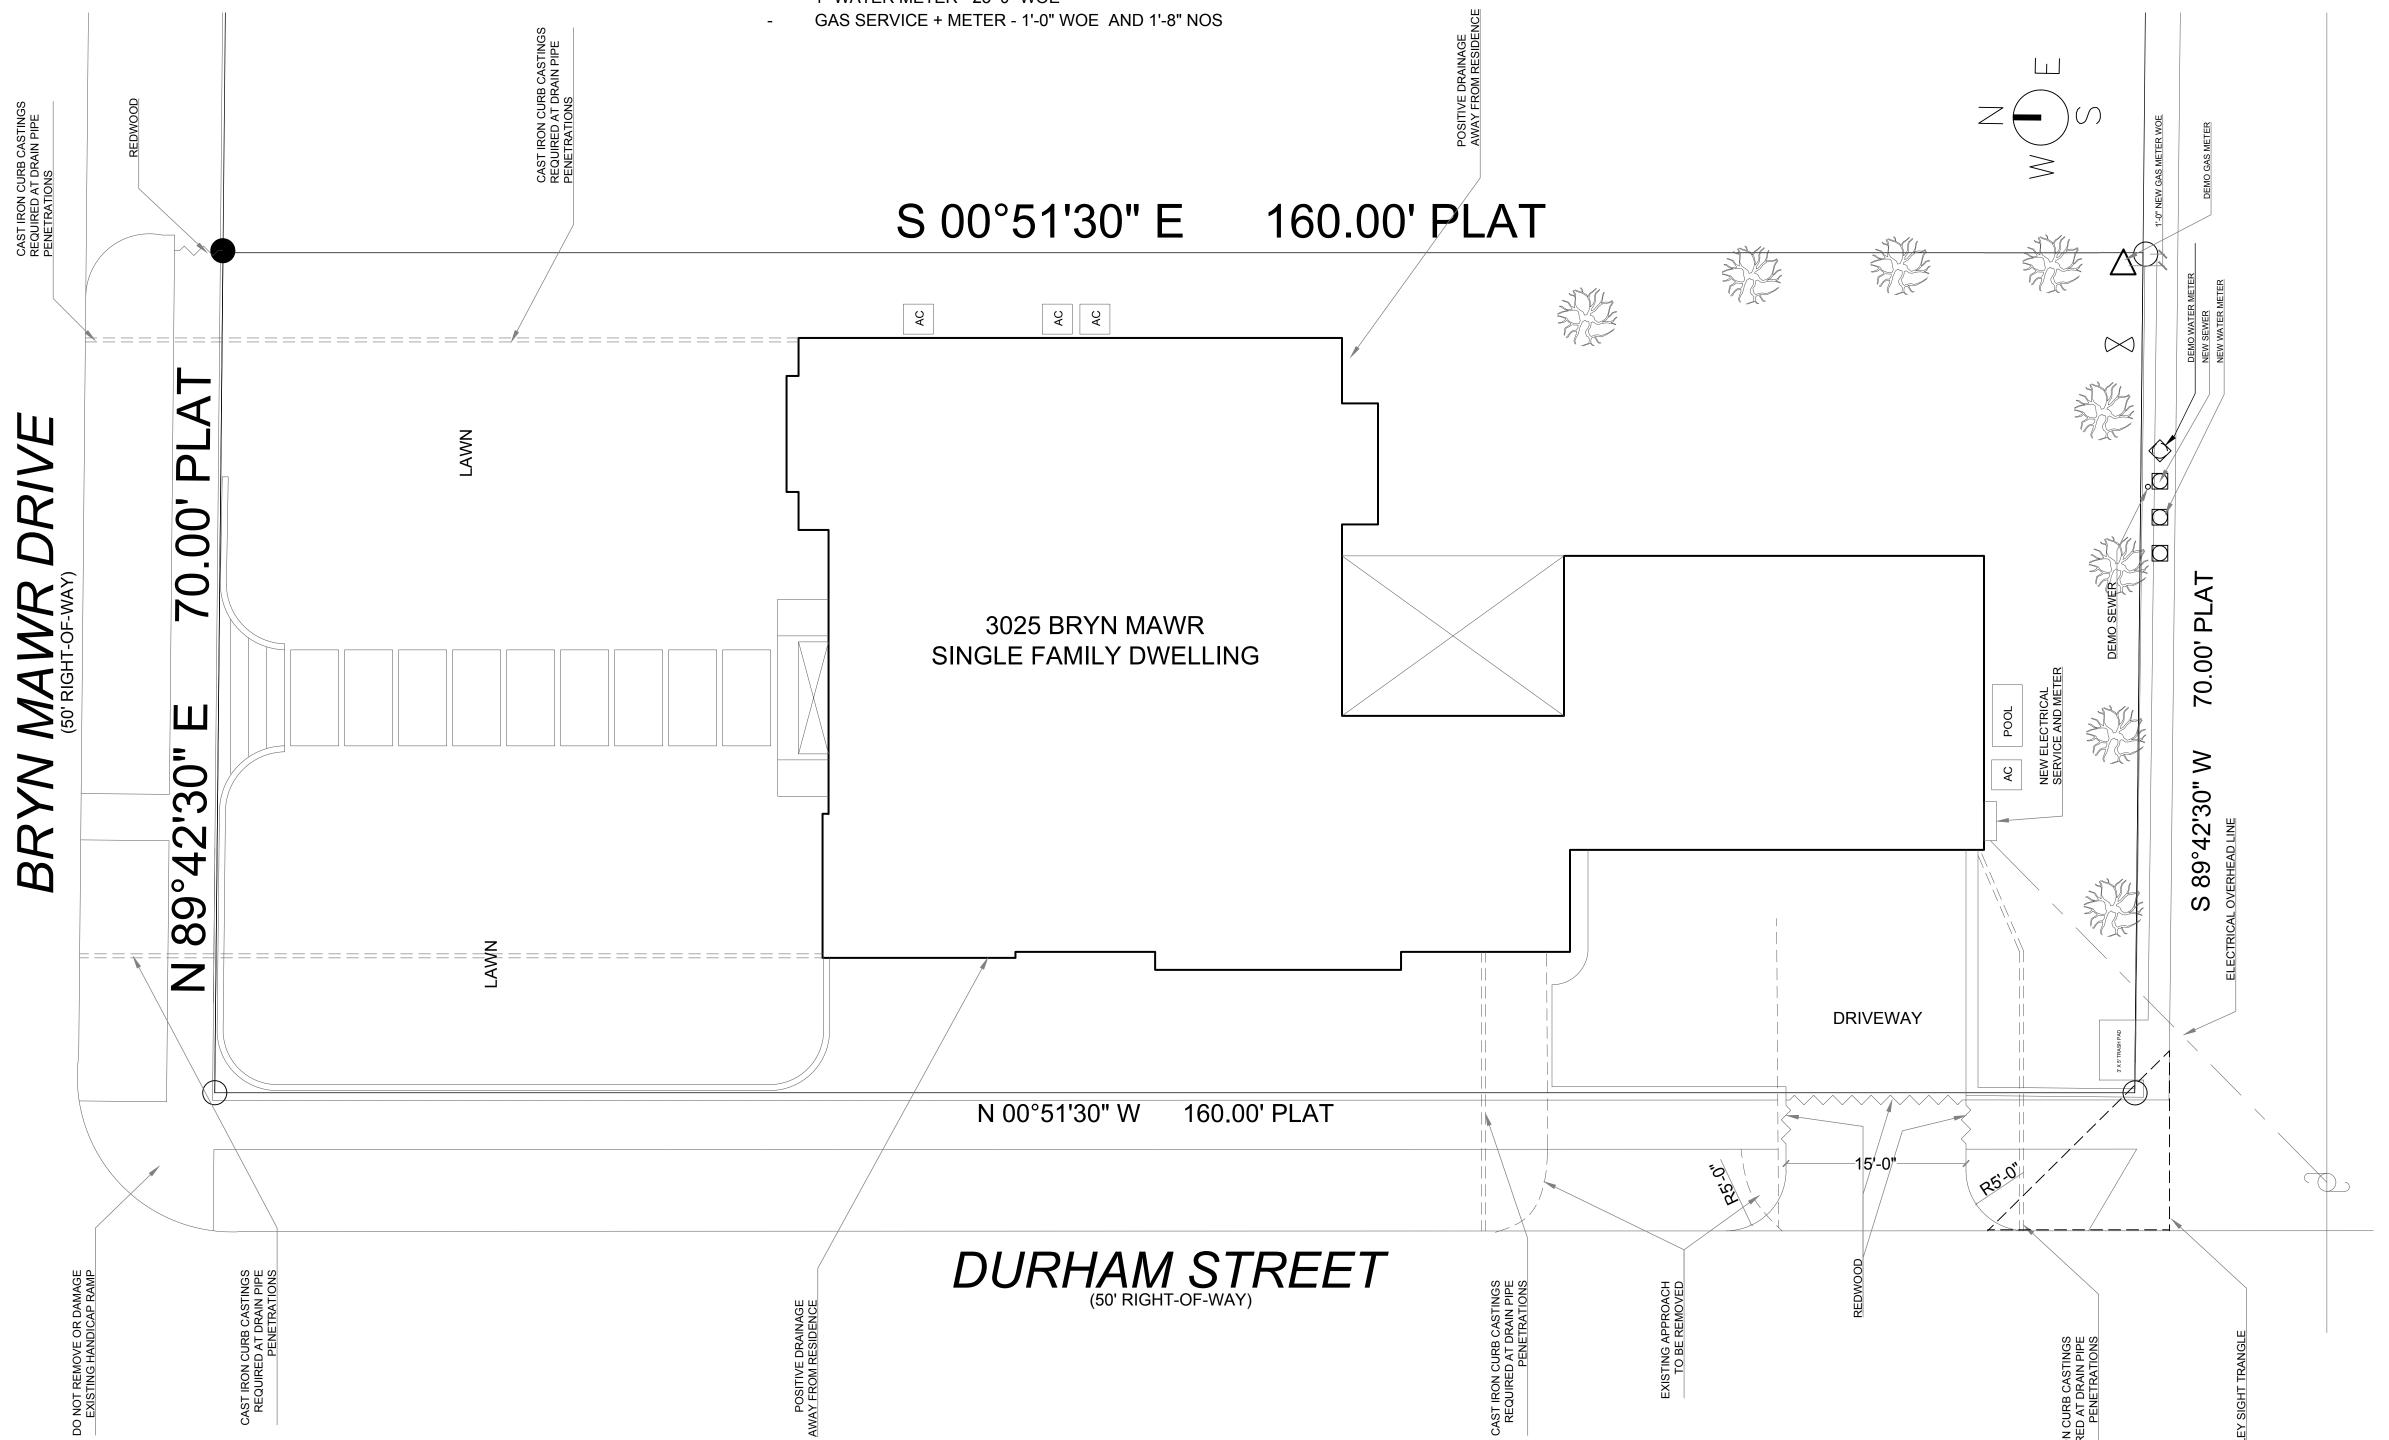
EXISTING UTILITIES

- SEWER 19'-6" TO BE REMOVED
- GAS SERVICE + METER 0'-3" WOE TO BE REMOVED
- WATER METER 16'-6" WOE TO BE REMOVED

NEW UTILITIES

- SEWER 19'-0" WOE
- 1.5" WATER METER 22'-0" WOE
- 1" WATER METER 25'-0" WOE





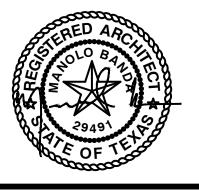
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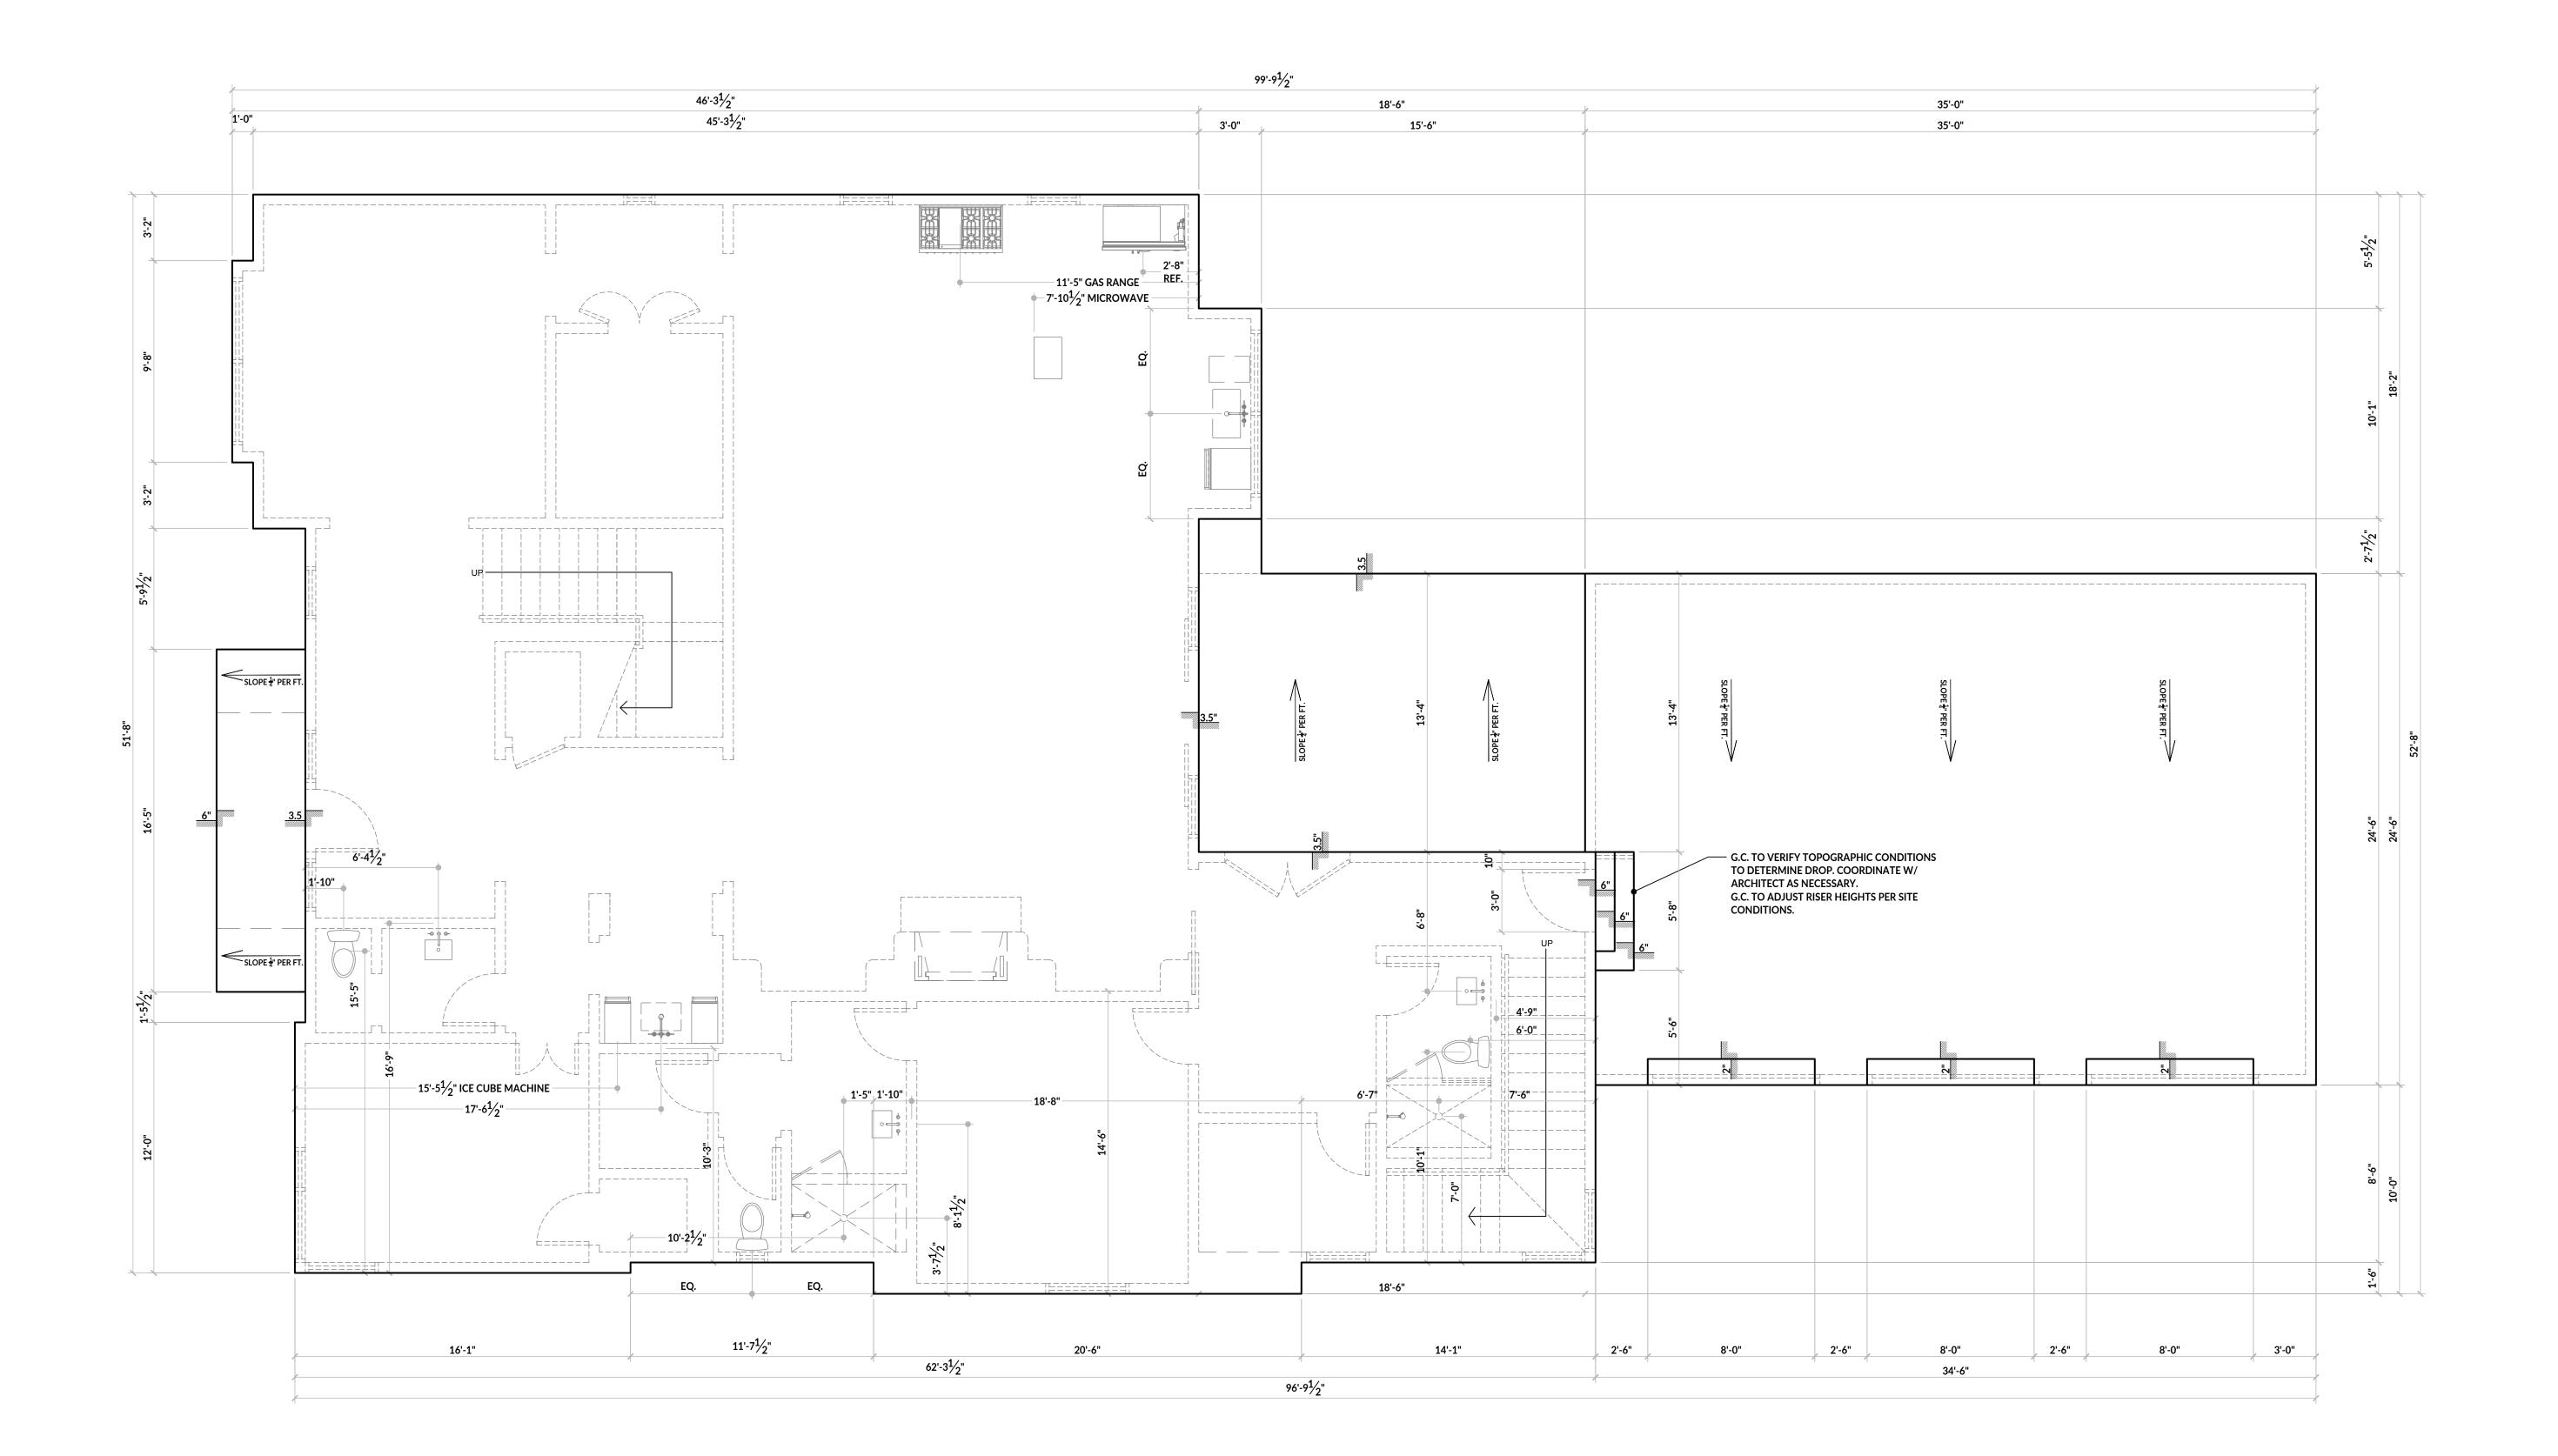
RIGHT-OF-WAY PLAN

FOUNDATION NOTES

- 1. REFER TO STRUCTURAL PLANS, THIS PLAN IS DIMENSIONAL FOUNDATION INFORMATION ONLY WITH ARCHITECTURAL DETAILS AND INFORMATION
- 2. ALL ANGLES ARE 90° UNLESS NOTED OTHERWISE
 3. OBJECTS THAT APPEAR TO BE IN ALIGNMENT
 SHOULD BE ASSUMED TO BE IN ALIGNMENT, UNLESS
 NOTED OTHERWISE
 4. VERIEY THE LOCATION OF ALL APPLIANCES
- NOTED OTHERWISE

 4. VERIFY THE LOCATION OF ALL APPLIANCES,
 PLUMBING FIXTURES AND ELECTRICAL FLOOR
 OUTLETS. REFERENCE INTERIOR DRAWING SHEETS

 5. VERIFY ALL TOP OF STEM AND RETAINING
 WALLS WITH CIVIL AND EXISTING CONDITIONS



MANOLO DESIGN STUDIO

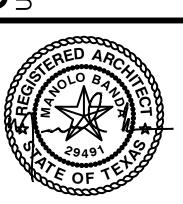
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PROJECT NO:	22014
PROJECT ISSUE DATE:	23.06.28
DRAWING TITLE:	

SLAB PLAN

As indicated

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PLAN CALCULATIONS		JLATIONS
	1ST STORY	2,672 SQ.FT.
	2ND STORY	3,302 SQ.FT.
	TOTAL	5,974 SQ.F
	GARAGE	857 SQ.FT.
	PORCHES	322 SQ.FT.
	TOTAL STRUCT.	7,153 SQ.F
I		



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 EG

 PROJECT NO:
 22014

 PROJECT ISSUE DATE:
 23.06.28

DRAWING TITLE:

1ST FLOOR PLAN

SCALE:
As indicated

A1.1

PLAN CALCULATIONS 2,672 SQ.FT. 3,302 SQ.FT. 2ND STORY TOTAL 5,974 SQ.FT. GARAGE 857 SQ.FT. **PORCHES** 322 SQ.FT. TOTAL STRUCT. 7,153 SQ.FT.

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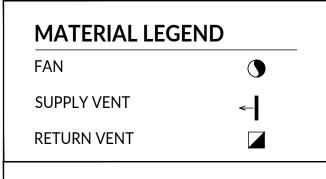
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2ND FLOOR PLAN



HVAC GENERAL NOTES

G.C. TO COORDINATE WITH HVAC CONSULTANT FOR ALL THE EXACT LOCATIONS OF GRILLES (RETURNS & SUPPLIES AS NEEDED) & PROPER GRILLE SIZING AS REQUIRED BY PROPOSED HVAC SYSTEM AND ALL APPLICABLE CODES. G.C. TO COORDINATE WITH ARCHITECT AS REQUIRED.



GENERAL NOTE

PLEASE REFER TO LIGHTING PLANS

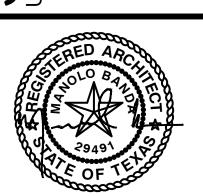
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23.06	PROJECT ISSUE DATE:
	DRAWING TITLE:

DRAWING TITLE:

1ST FLOOR REFLECTED CEILING PLAN



HVAC GENERAL NOTES

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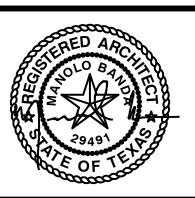


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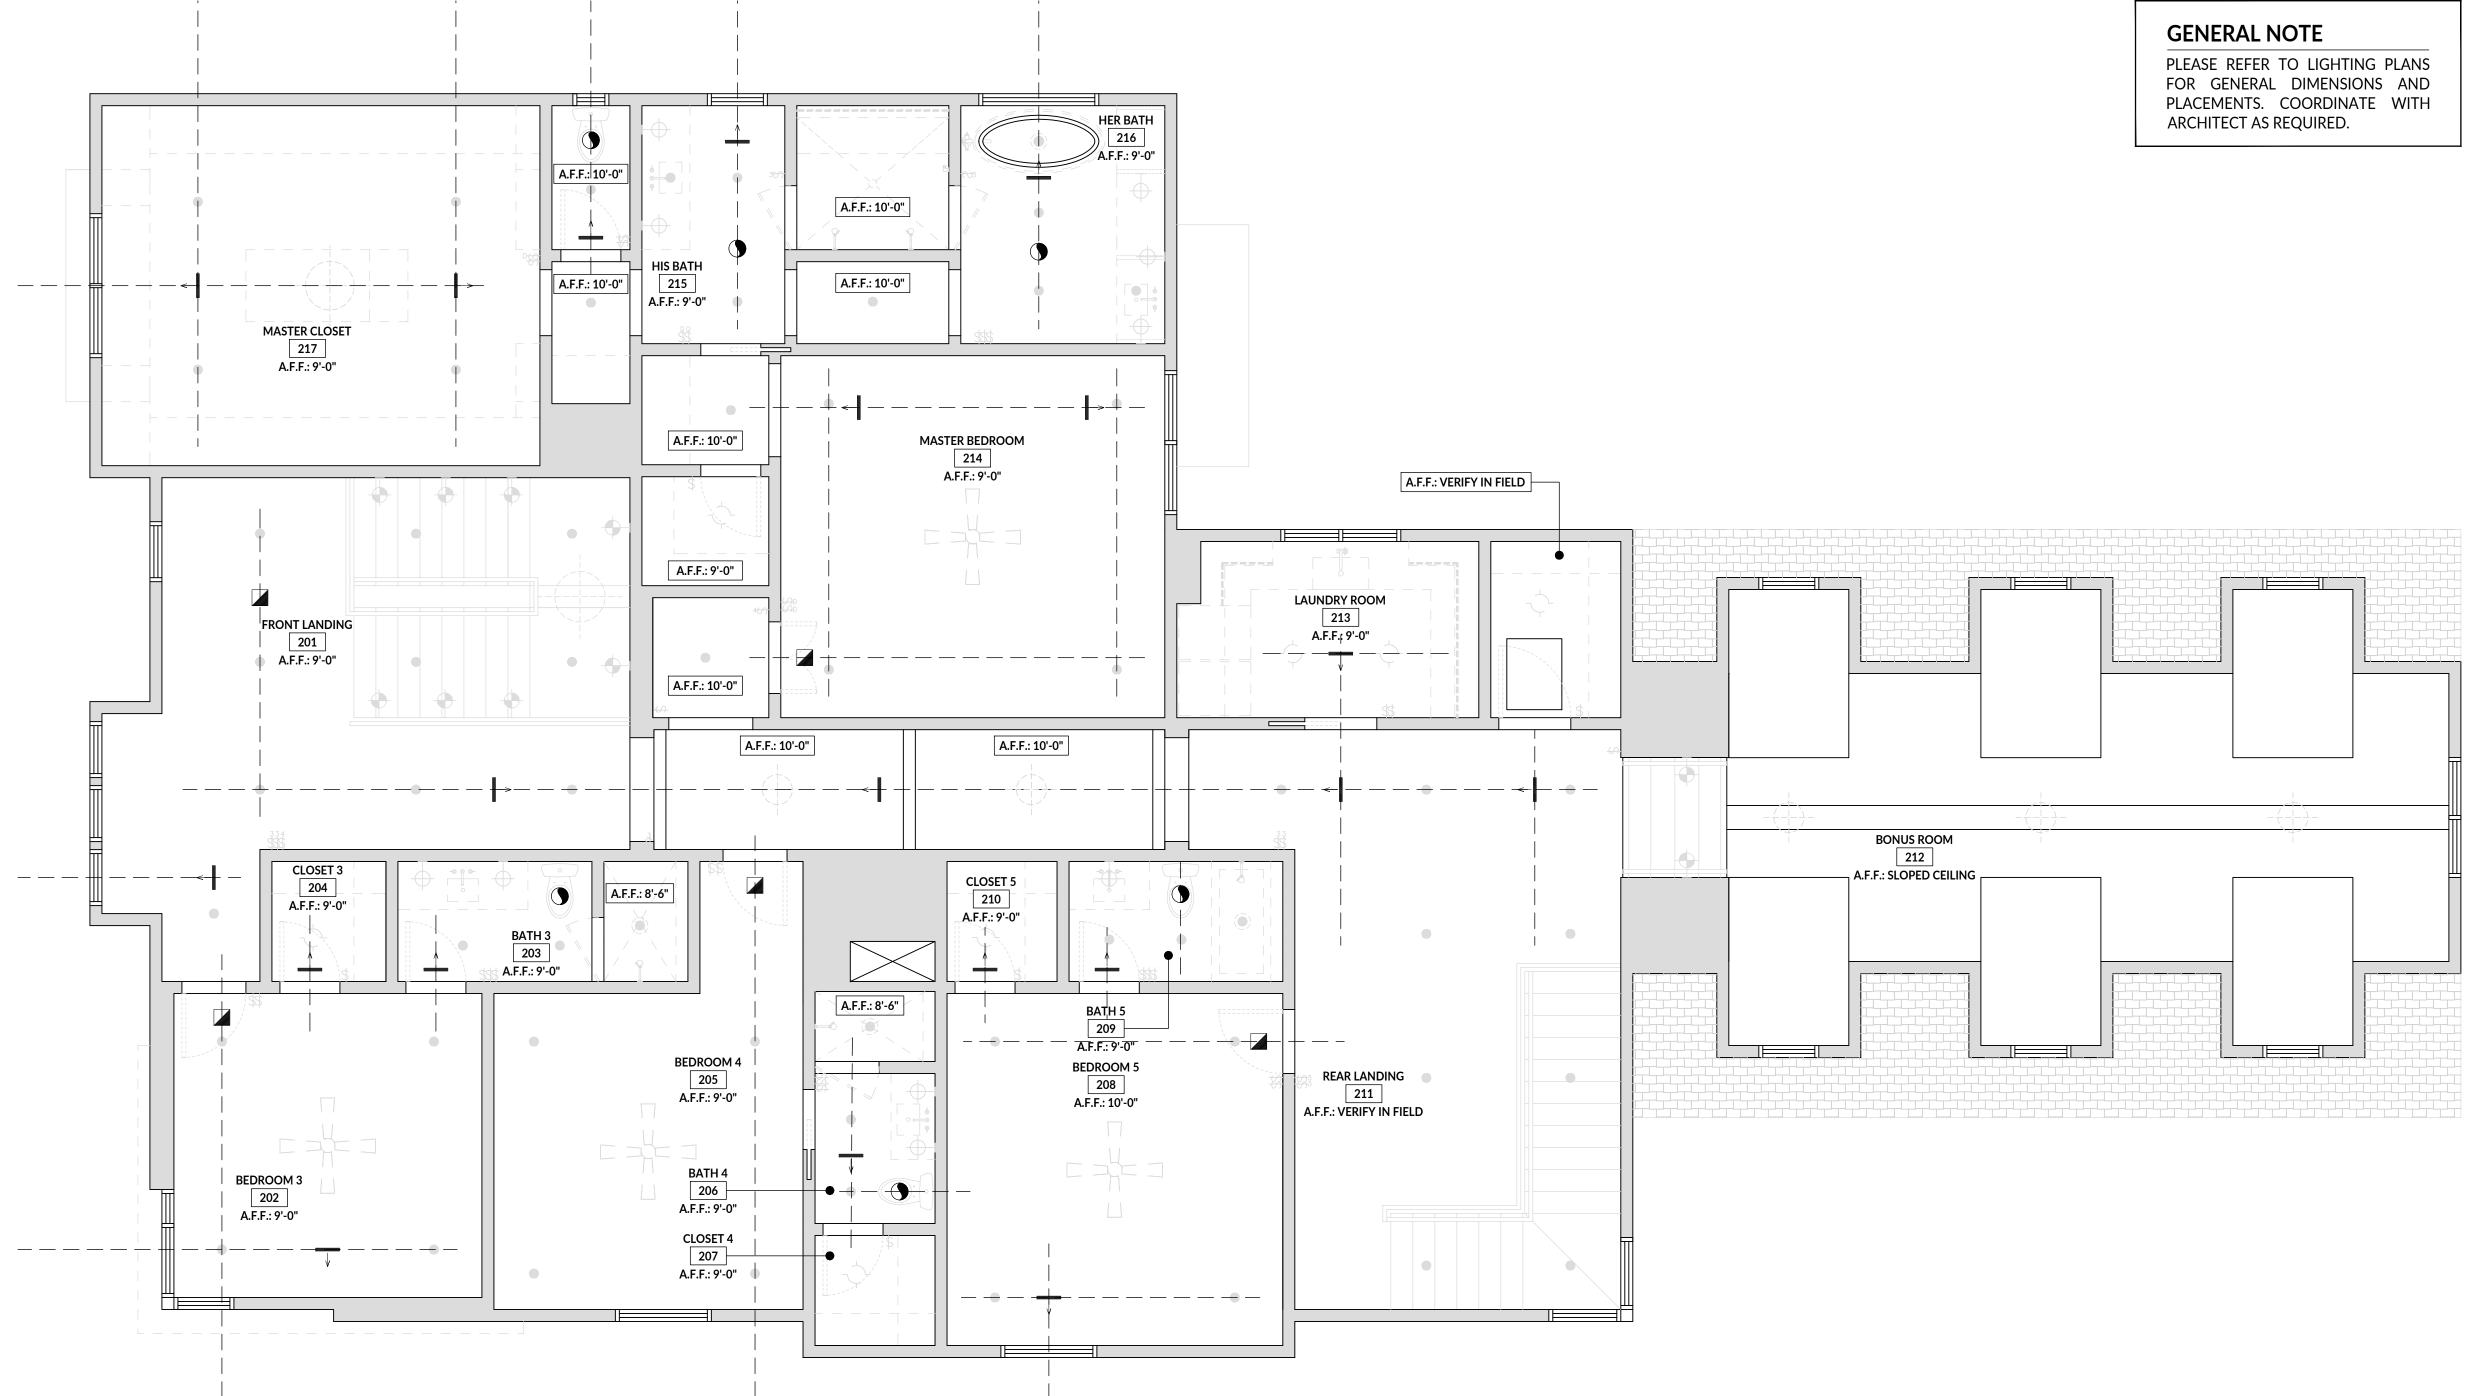


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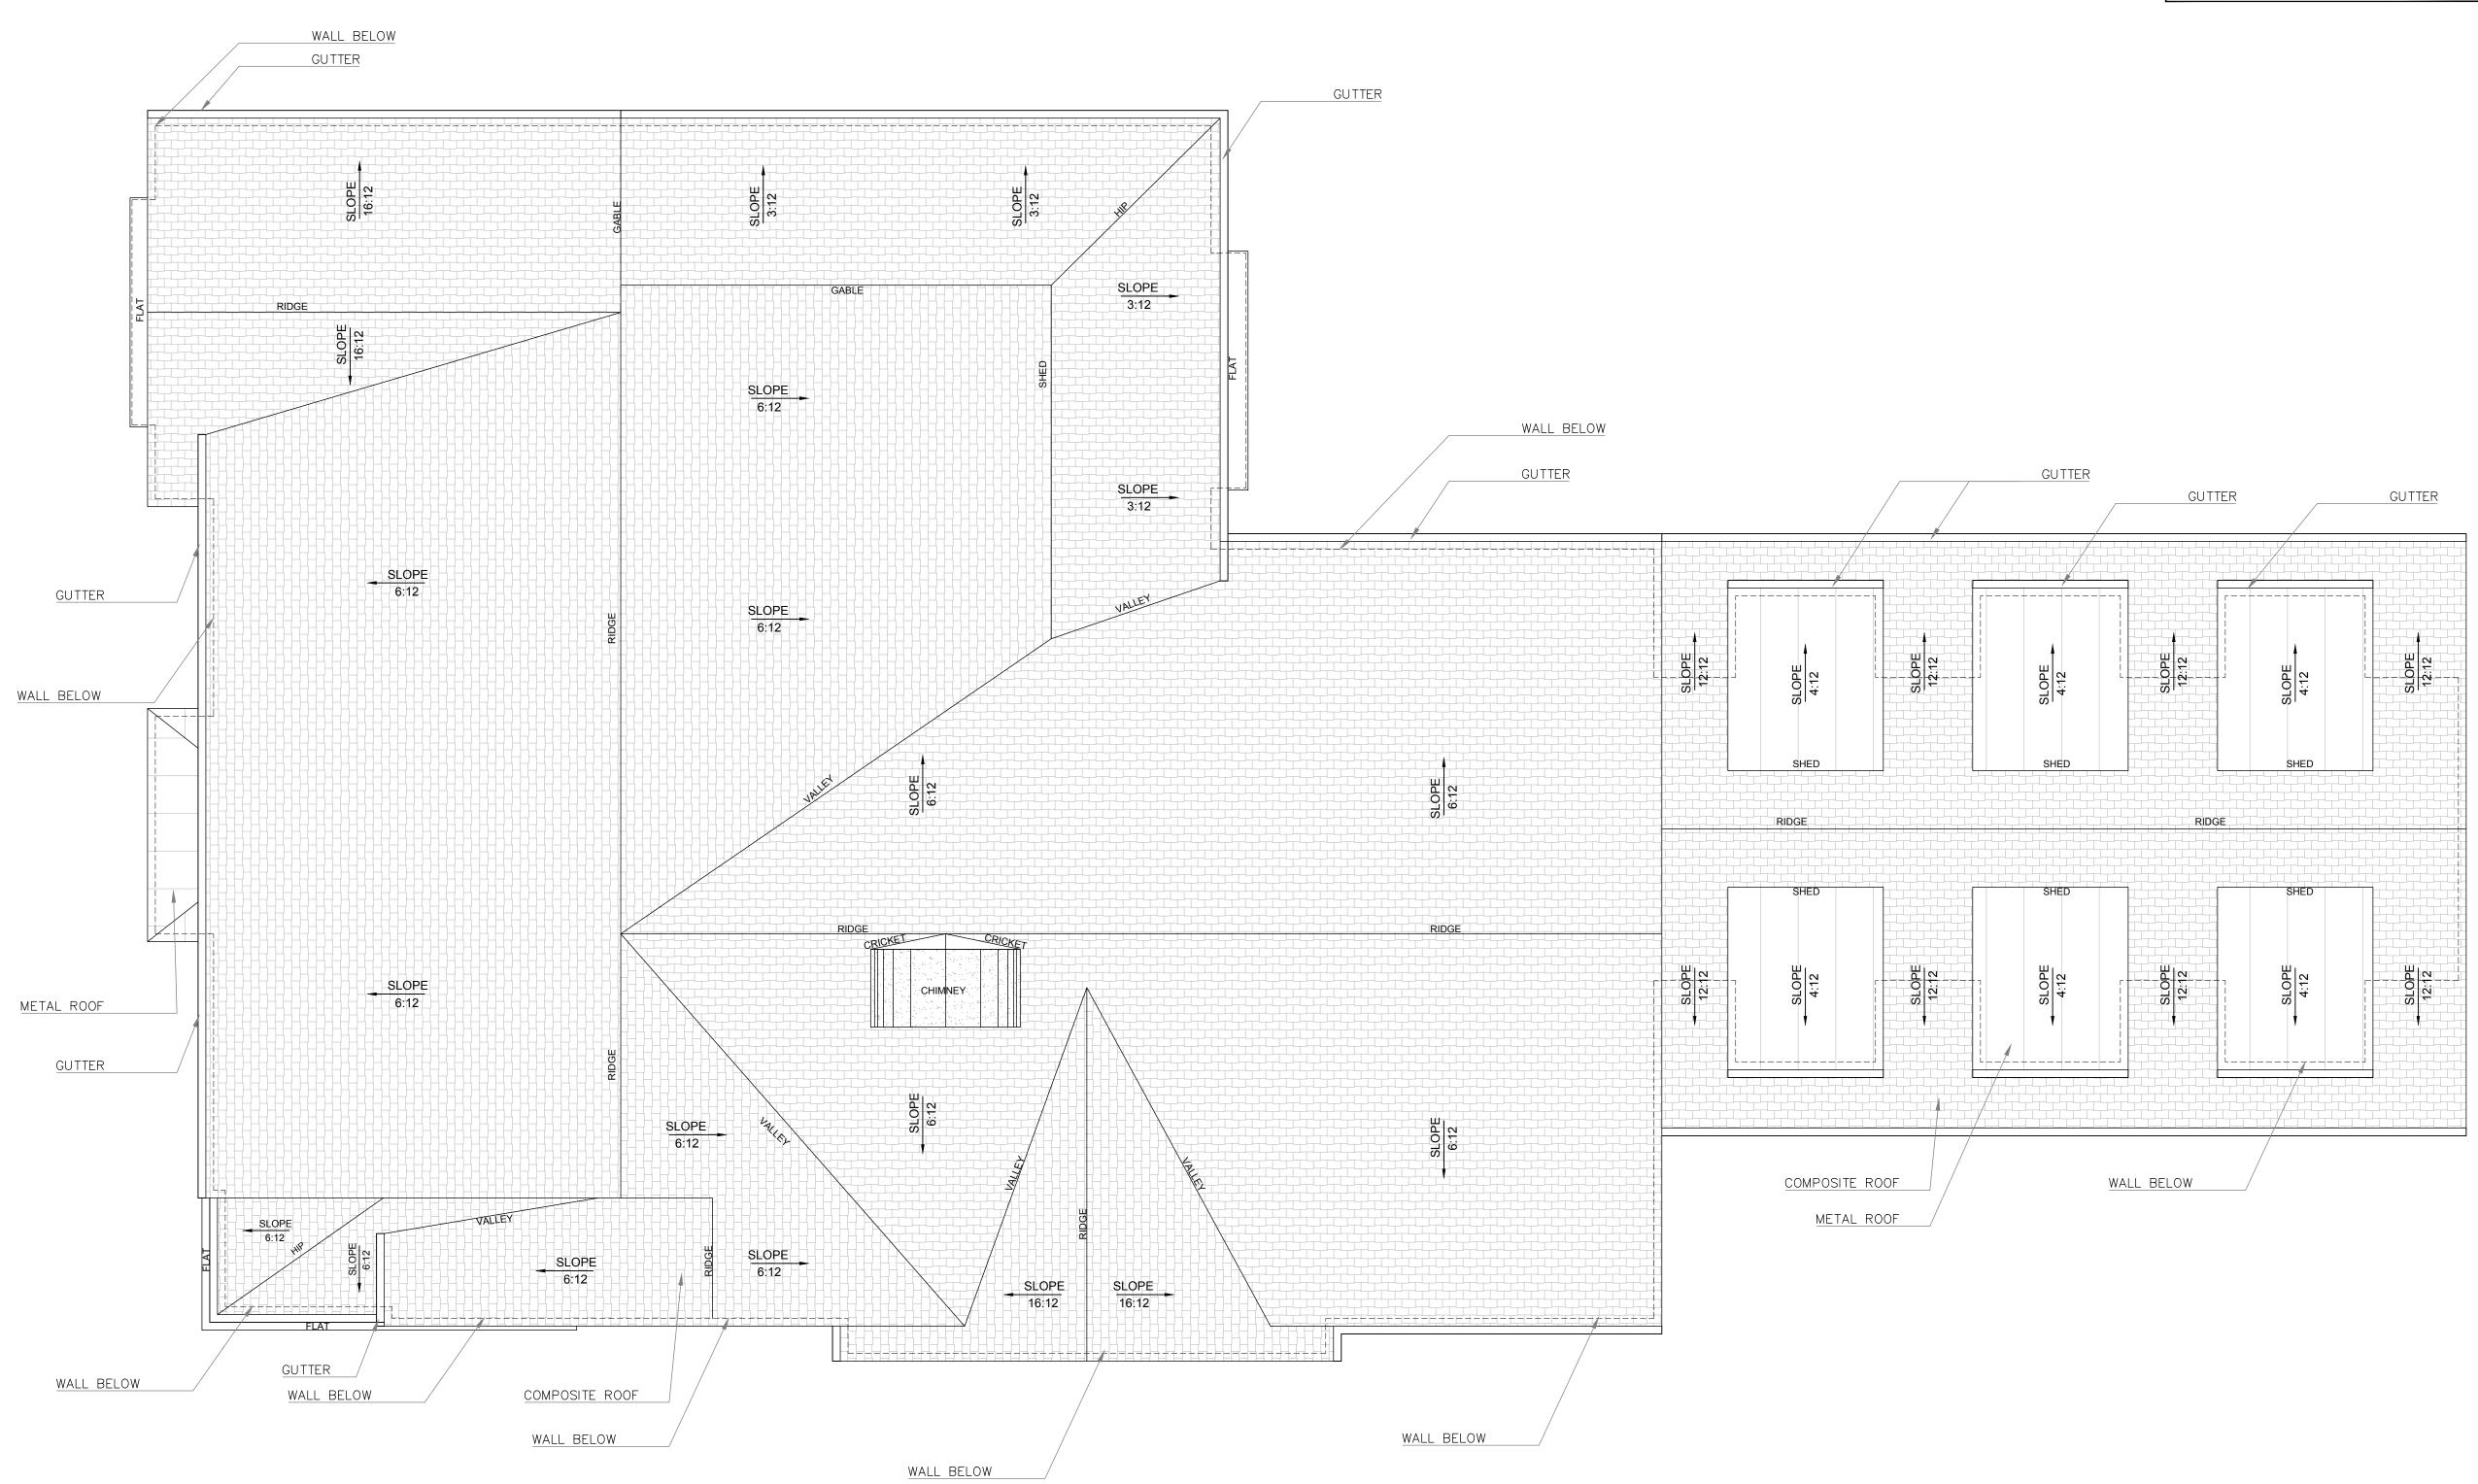
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22.04.4	PROJECT ISSUE DATE:
23.06.2	
	DRAWING TITLE:

DRAWING TITLE:

2ND FLOOR REFLECTED **CEILING PLAN**



COMPOSITE ROOF [INSERT SPEC] [INSERT SPEC] [INSERT SPEC]	
METAL ROOF [INSERT SPEC] [INSERT SPEC] [INSERT SPEC]	
STUCCO [INSERT SPEC] [INSERT SPEC] [INSERT SPEC]	
LAP SIDING [INSERT SPEC] [INSERT SPEC] [INSERT SPEC]	
PANEL SIDING [INSERT SPEC] [INSERT SPEC] [INSERT SPEC]	



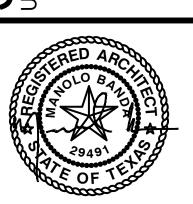
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PROJECT NO:	22014
PROJECT ISSUE DATE:	23.06.28
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ROOF PLAN

SCALE:
As indicated

A1.5

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service, shall remain the property of the Architect, Manolo Design Studio LLC. The Architect shall retain all common law, statutory and other supervised rights, including copyright thereto. The use of this drawing shall be restricted to the original site for which it was appeared and rublication thereof in purposch light the state of the original site of the property of the purposch light the state of the purposch light the pu

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' :	E
O:	2201
SUE DATE: 23	.06.2
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1ST FLOOR FINISH PLAN

CALE:
As indicated

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A1.6





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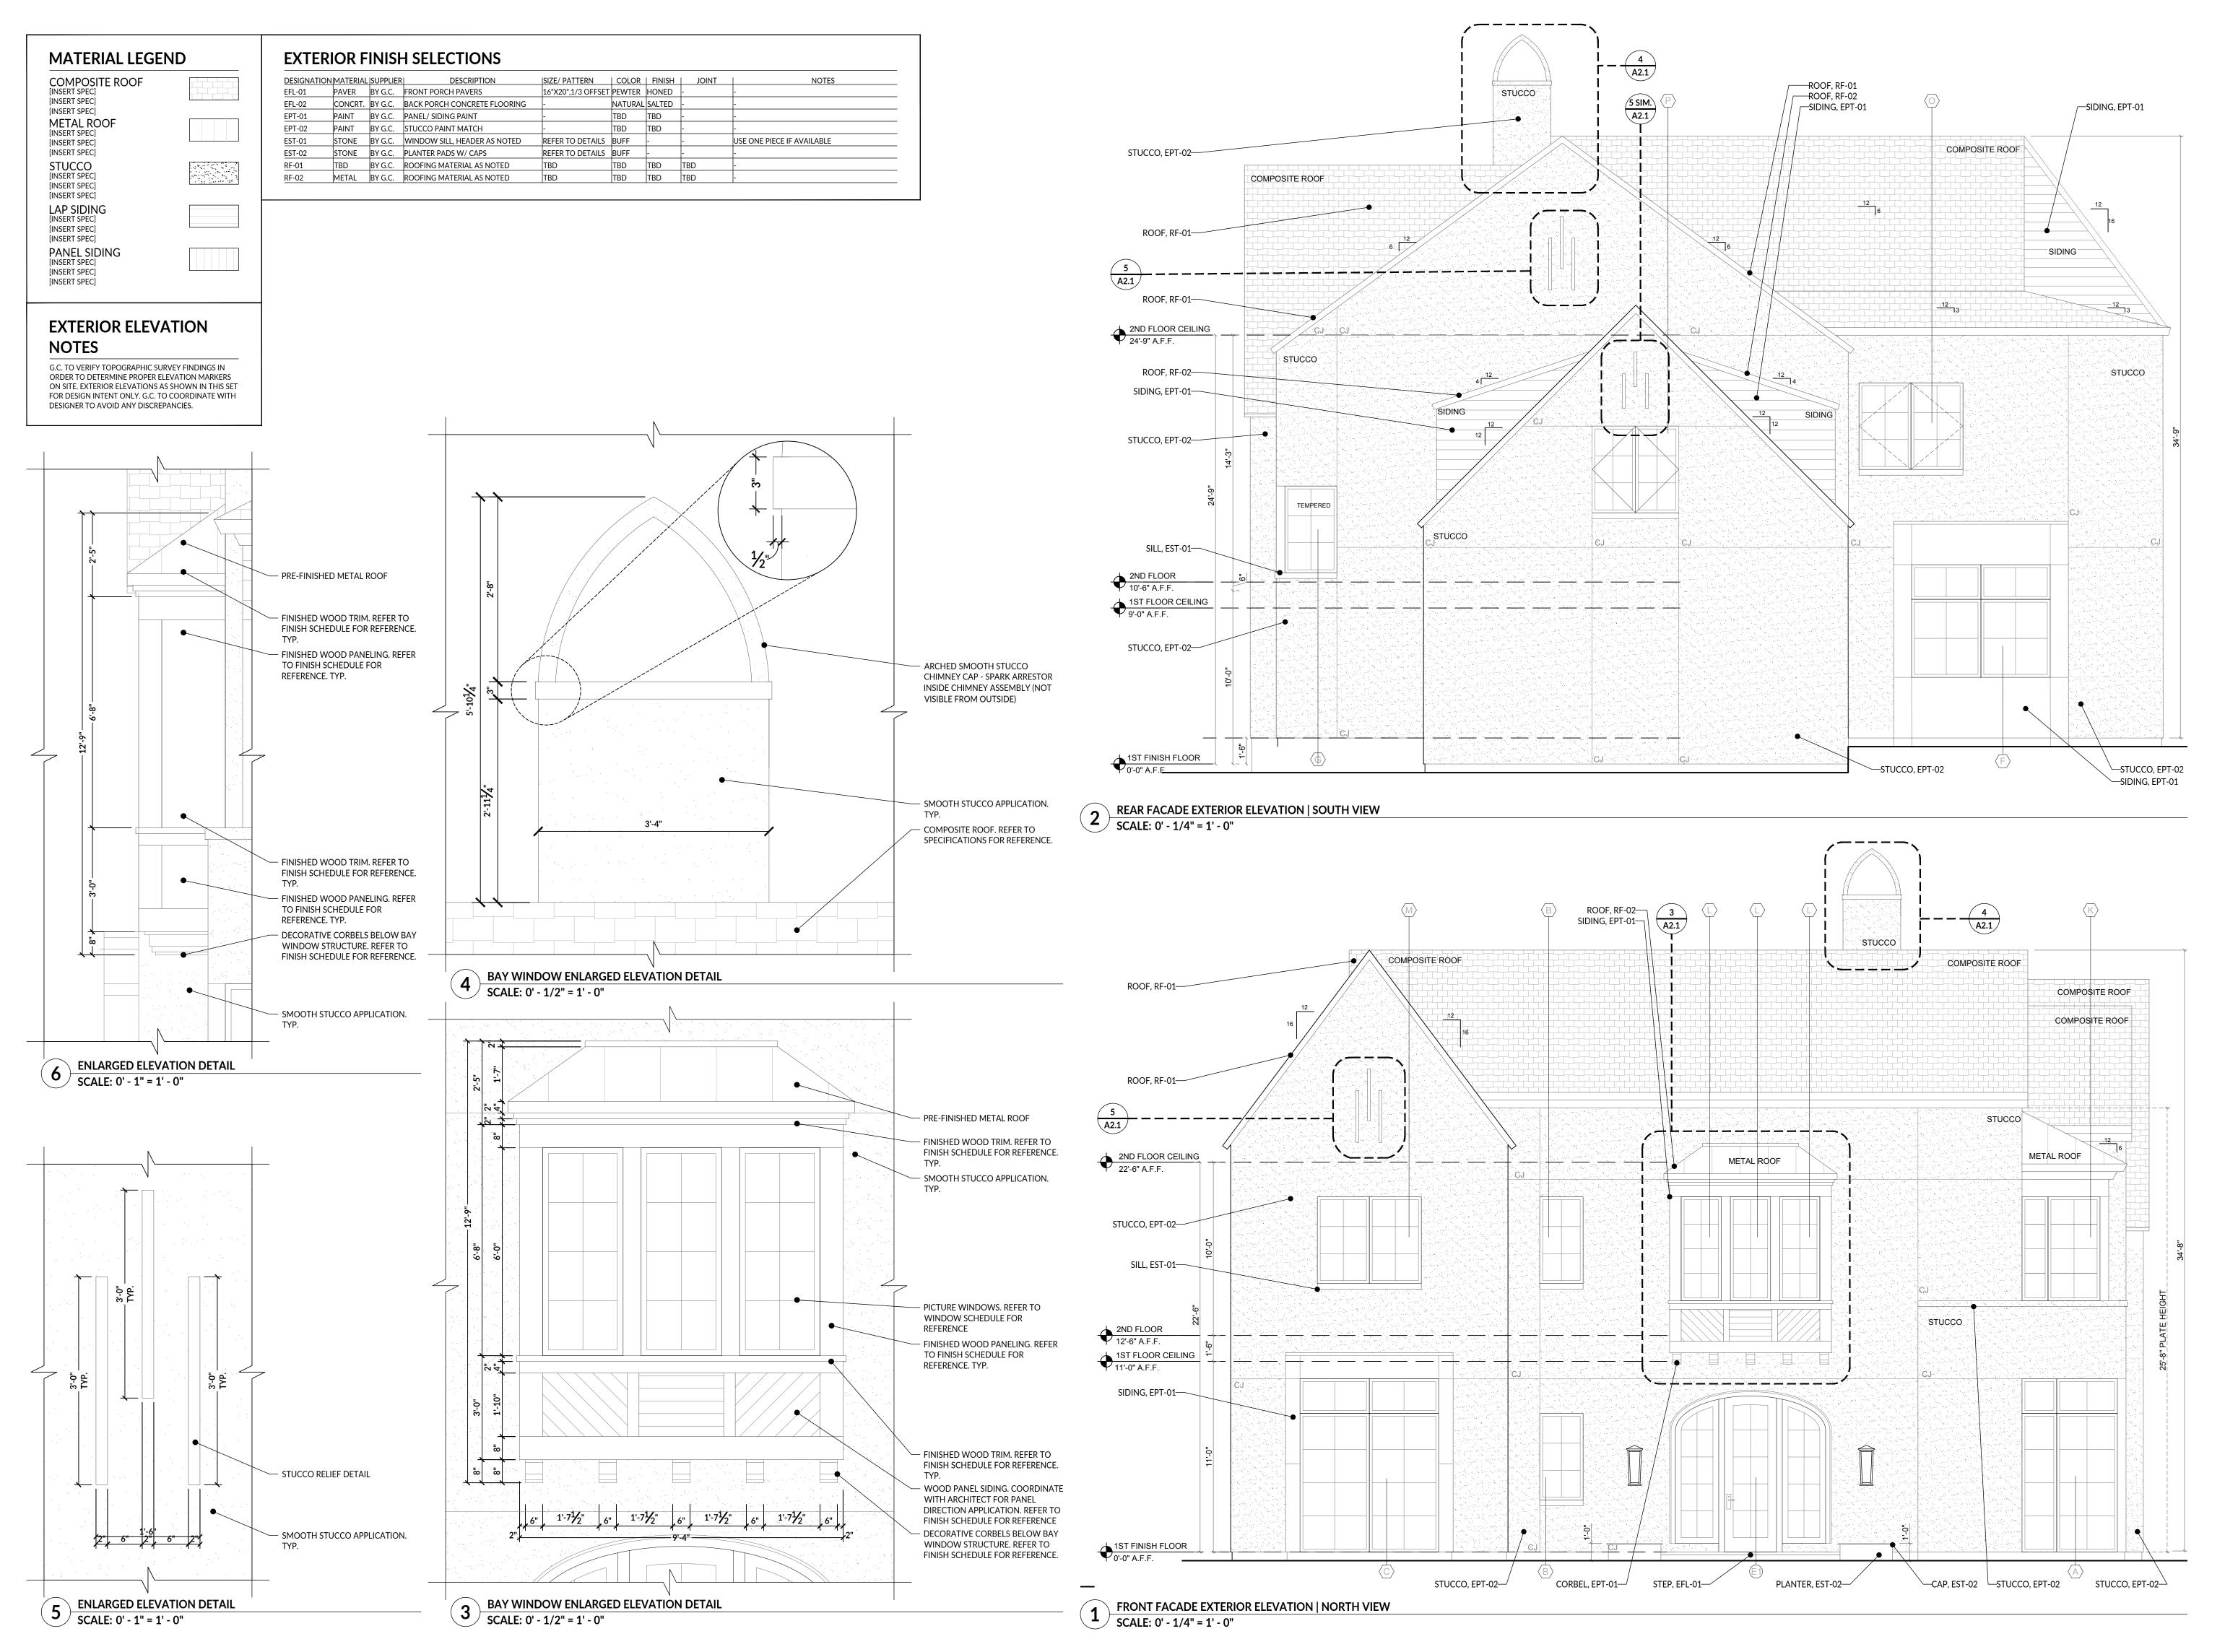
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CD SET	2023.06.28

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23.06.2	PROJECT ISSUE DATE:
	DRAWING TITLE:

1ST FLOOR FINISH PLAN





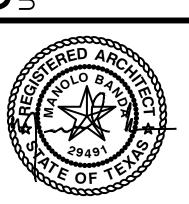
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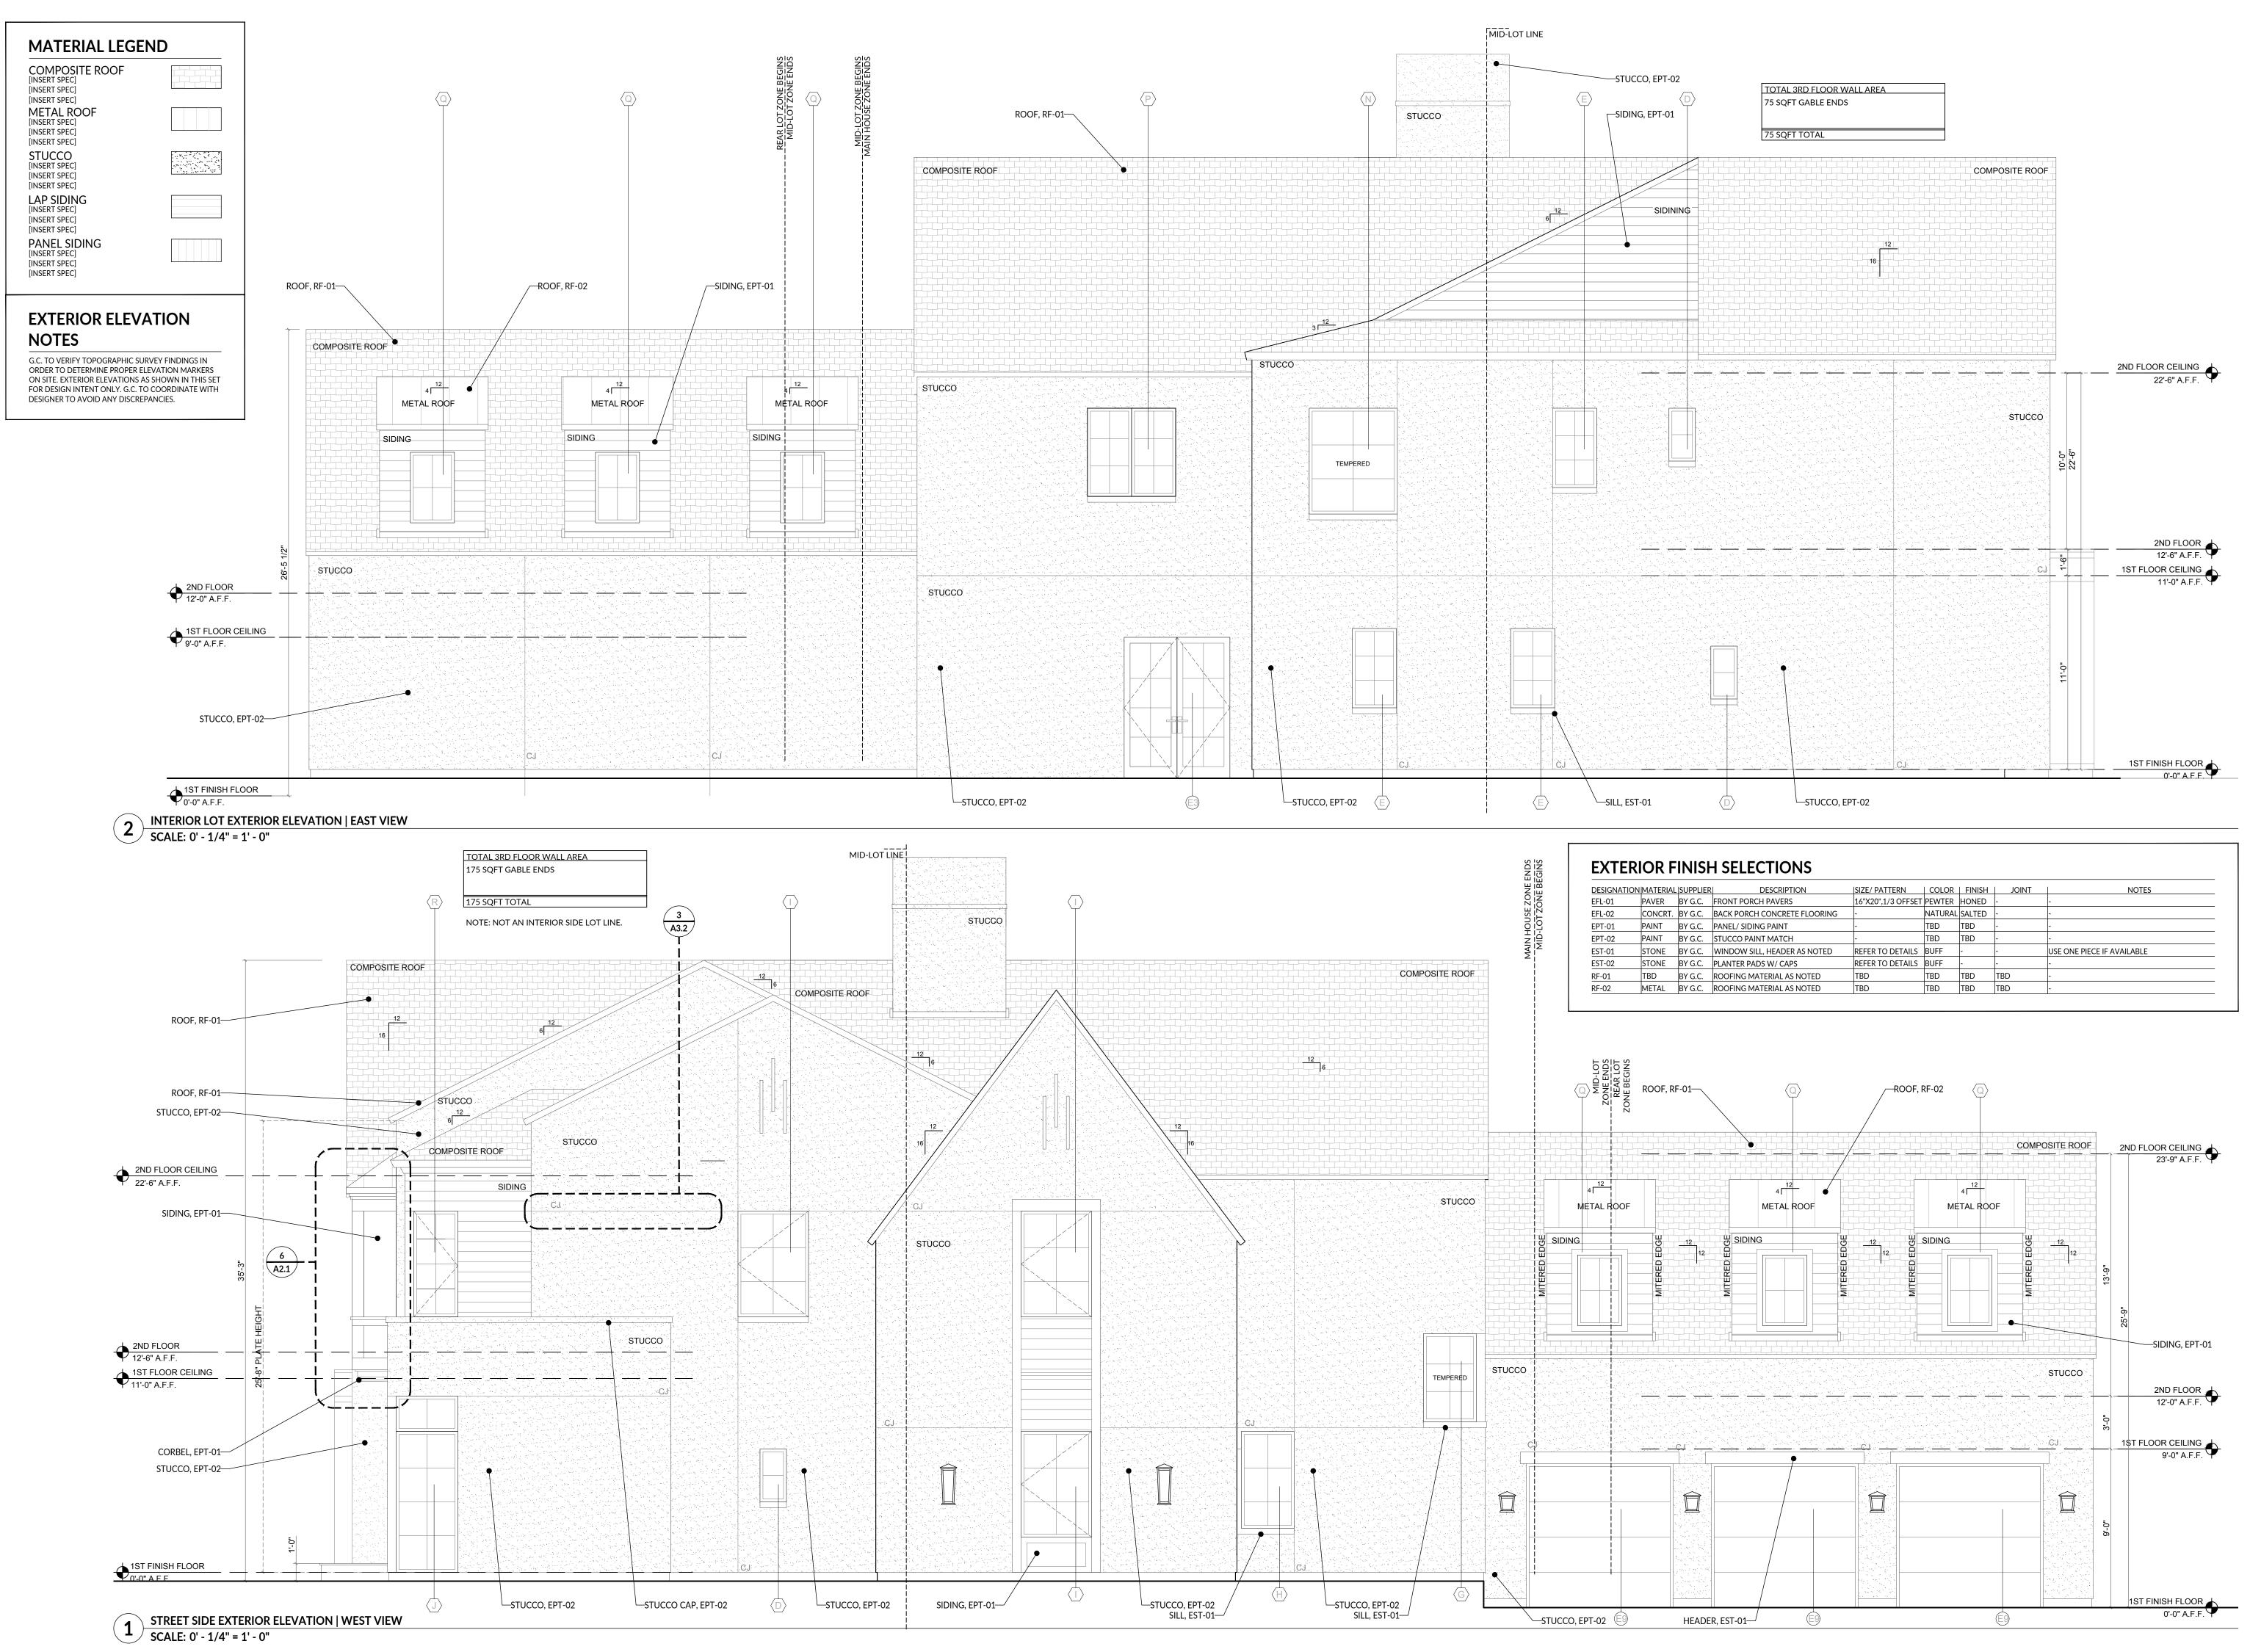
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EXTERIOR ELEVATIONS



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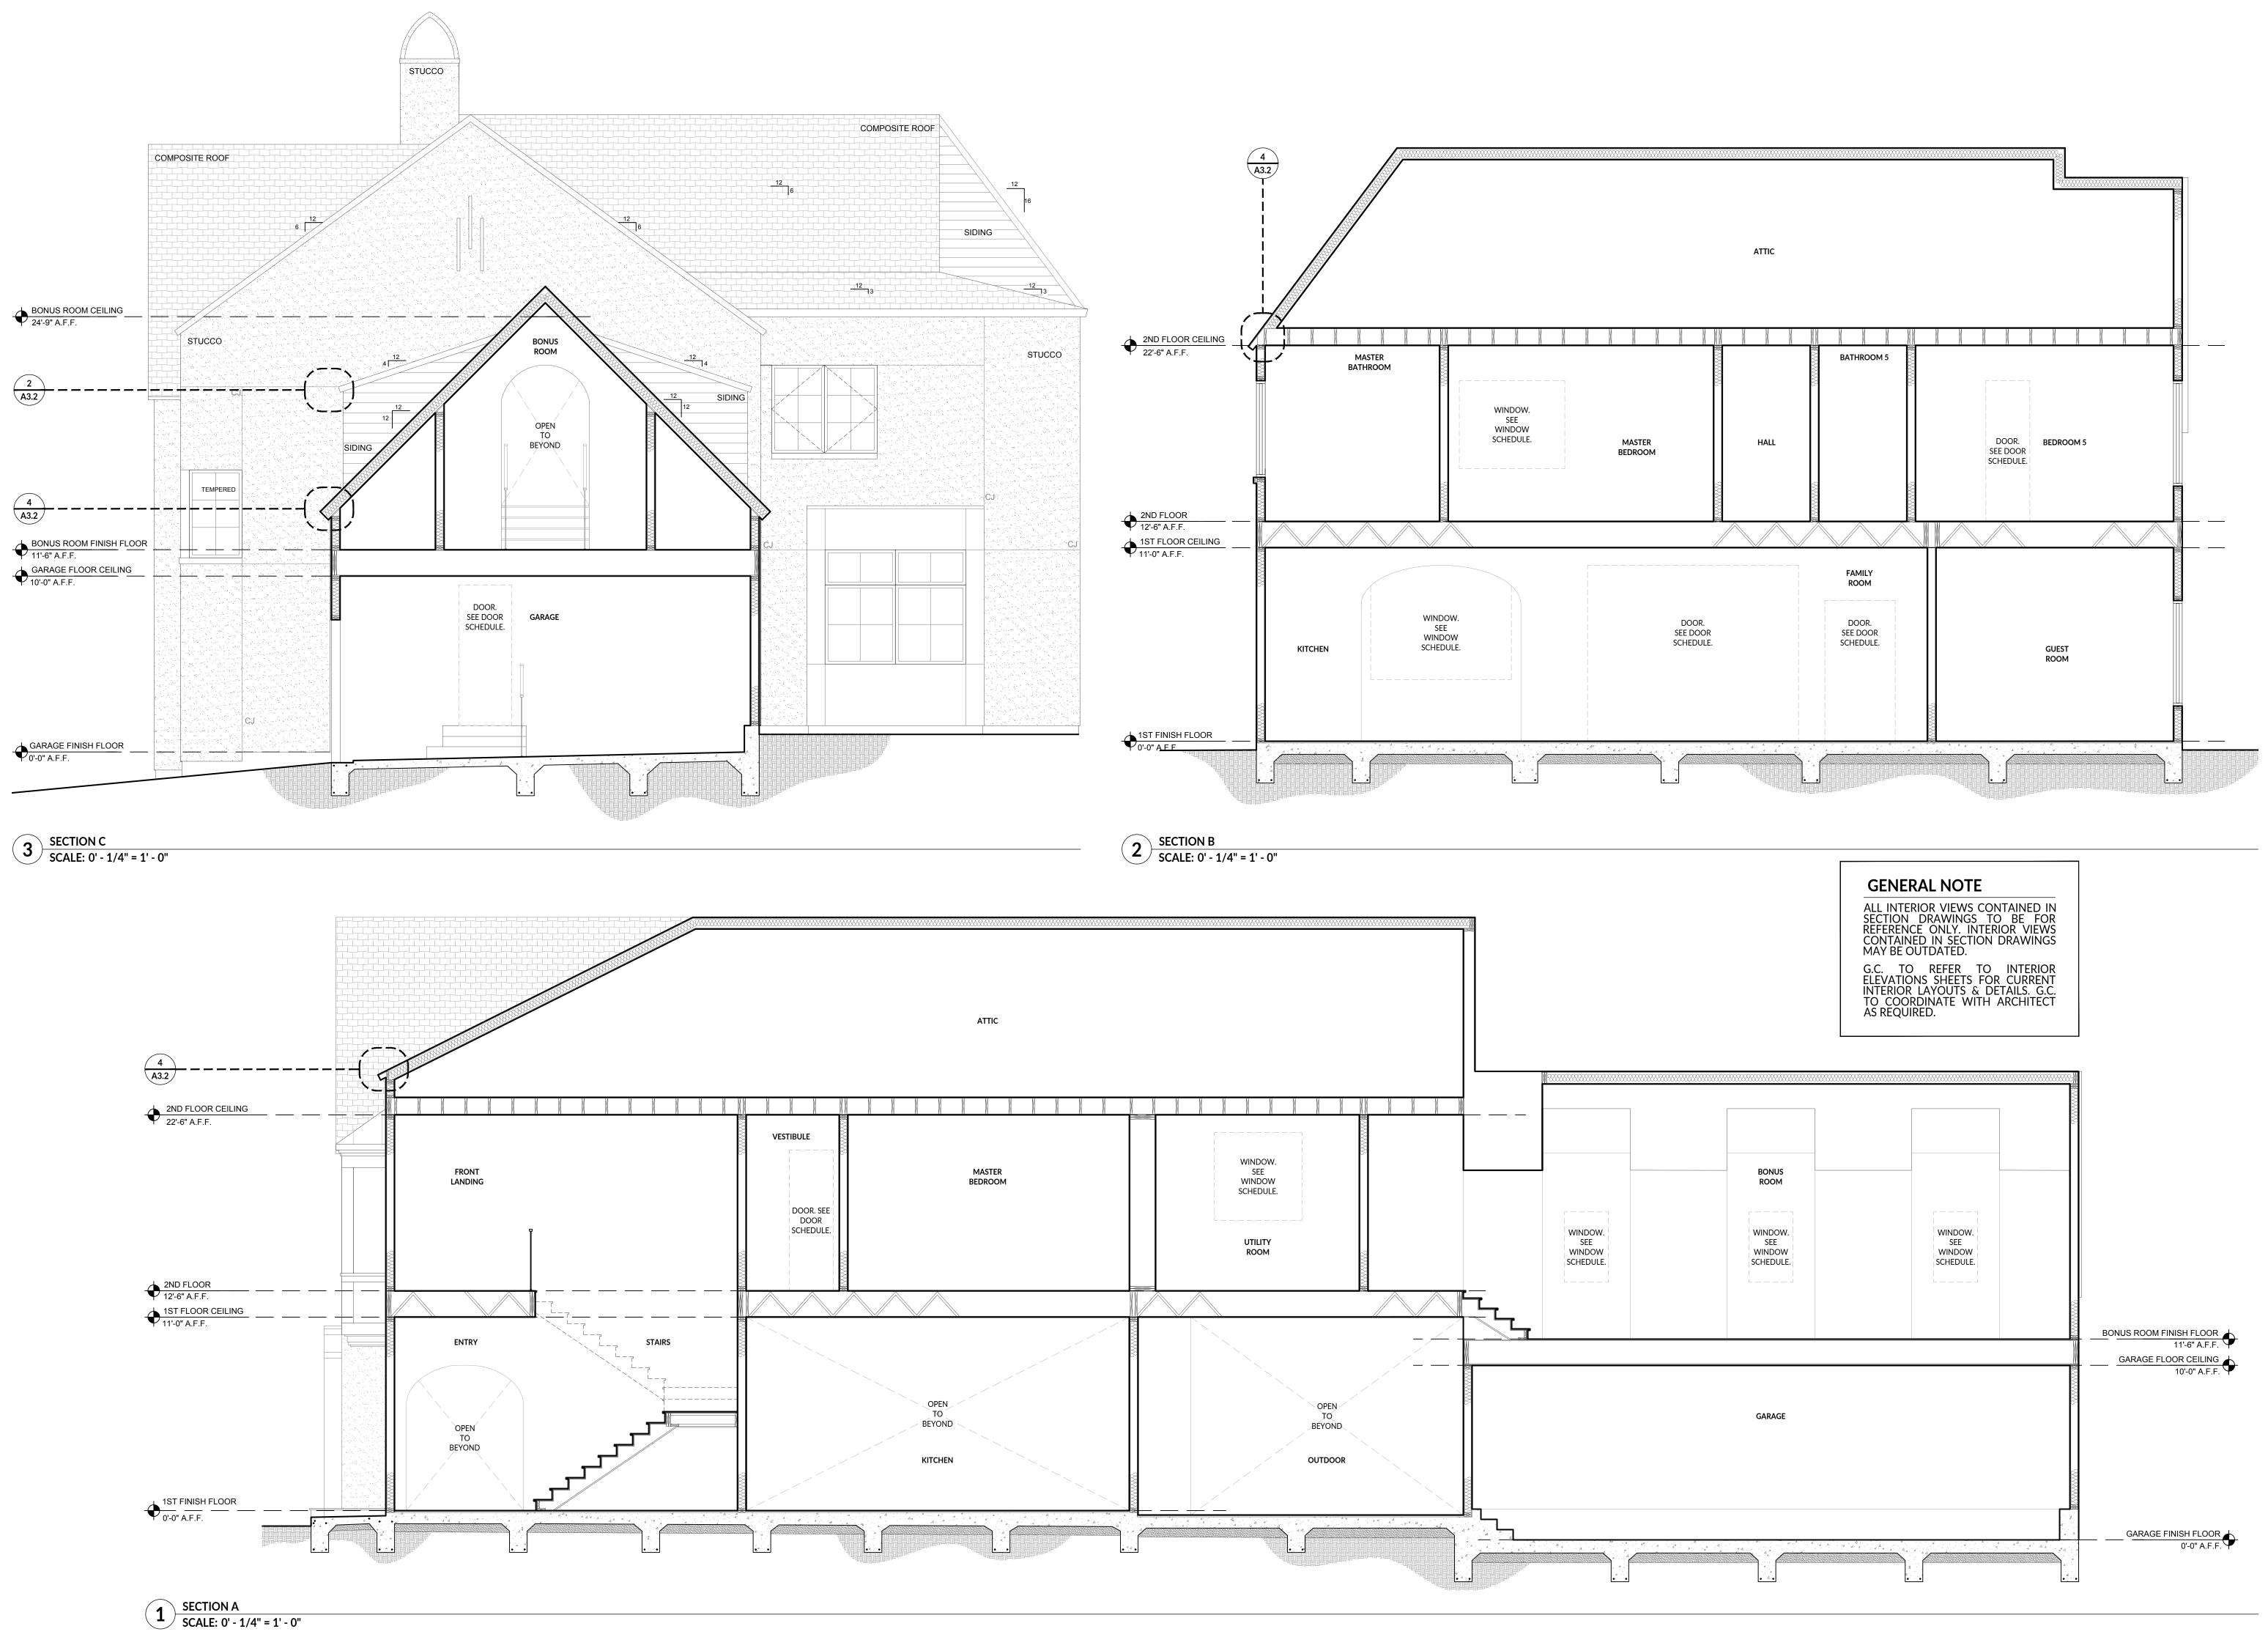
DRAWING TITLE:

EXTERIOR ELEVATIONS

SCALE:

As indicated

A2.2



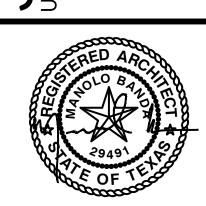
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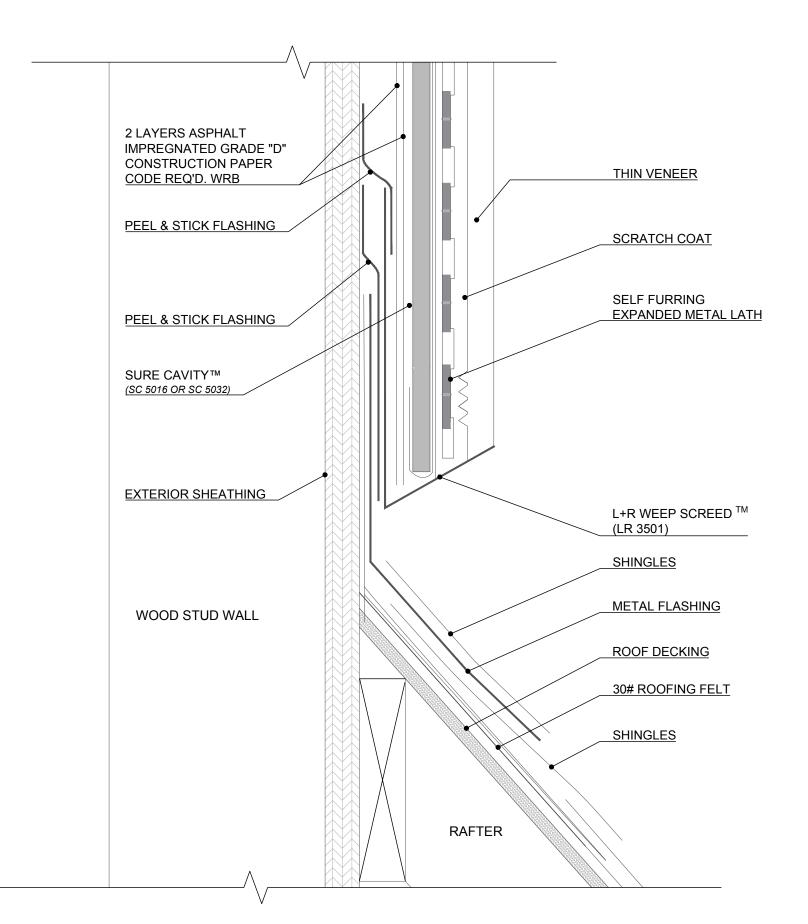
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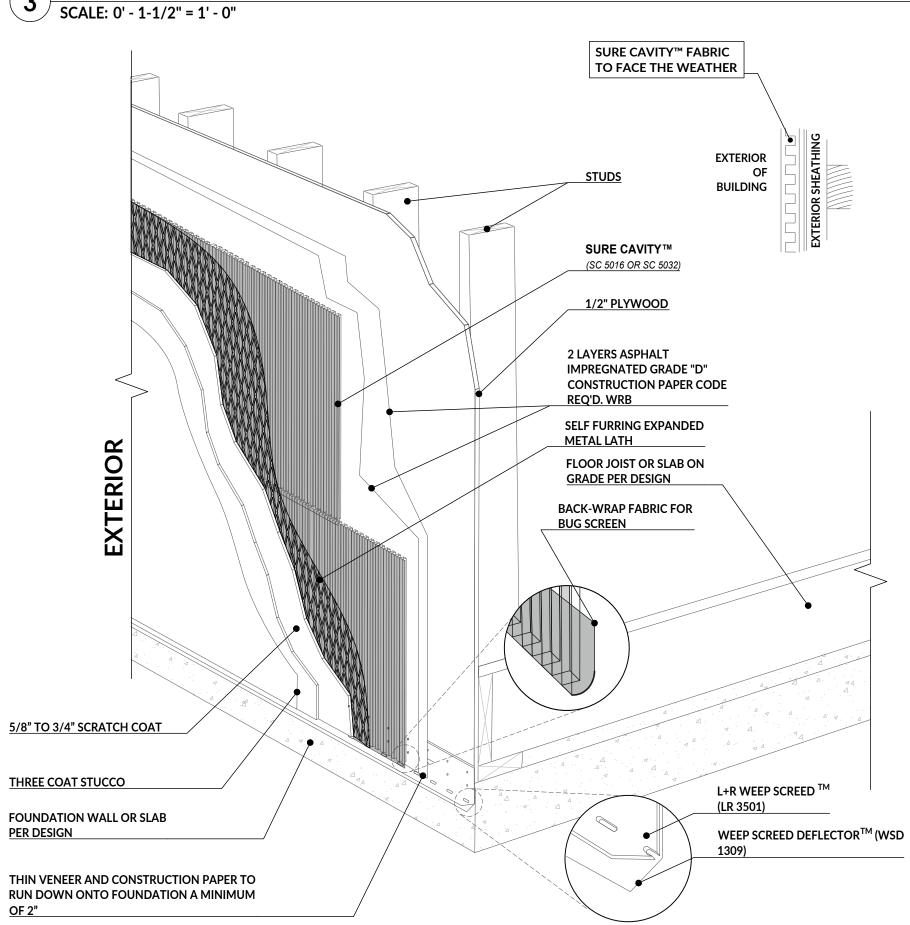
SECTION DETAILS

As indicated

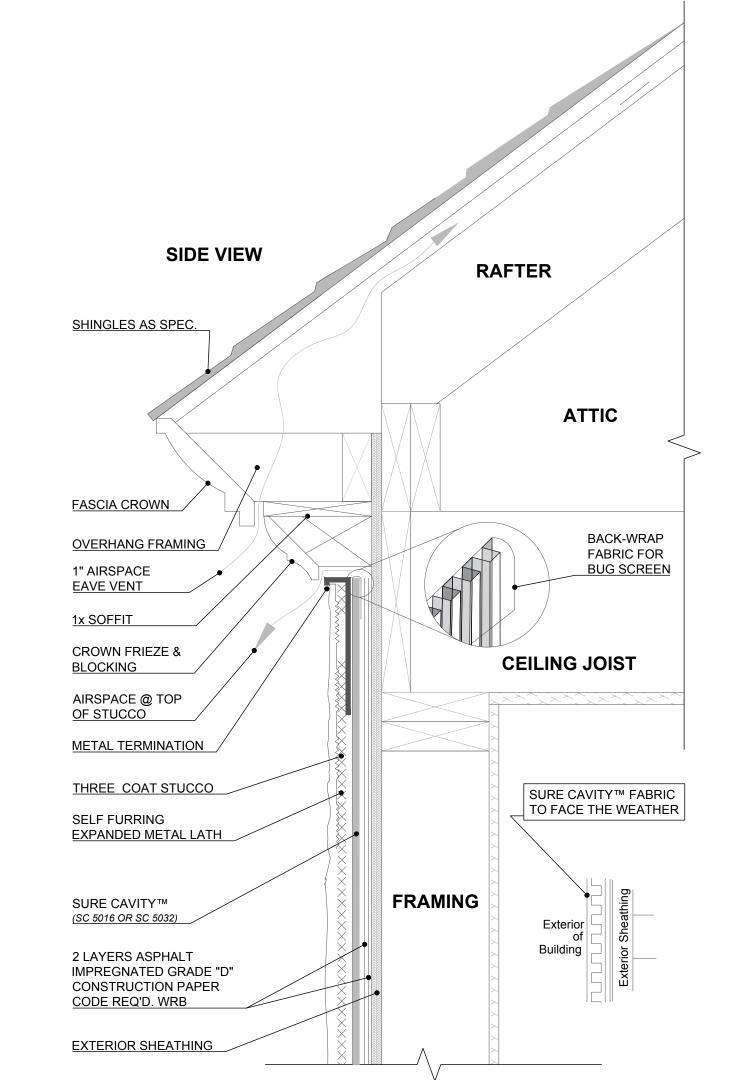
A3.1



ROOF TO THIN VENEER SIDE WALL TERMINATION DETAIL



L&R WEEP SCREED & DEFLECTOR @ BOTTOM OF THIN WENEER WALL INSTALLATION / SCALE: 0' - 1-1/2" = 1' - 0" SCALE: 0' - 1-1/2" = 1' - 0"

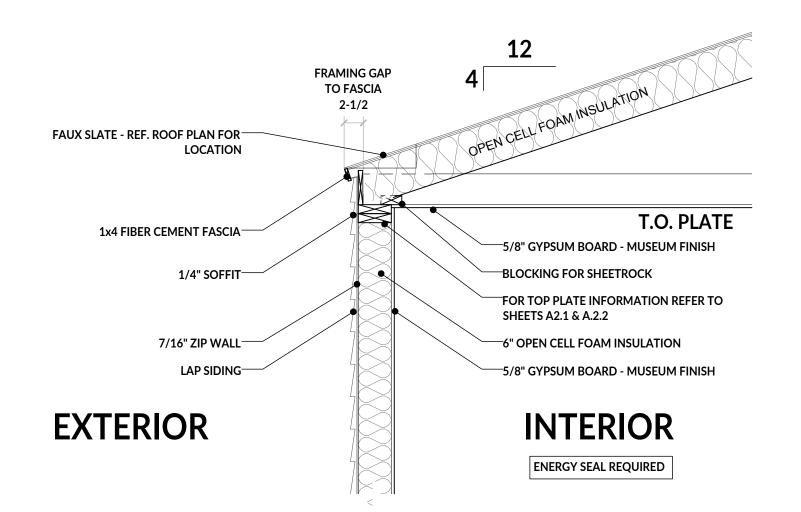


THIN VENEER TO TOP-VENTED WALL STOPPED AT SOFFIT INSTALLATION SCALE: 0' - 1-1/2" = 1' - 0"

SIDE VIEW

CONTROL JOINT WIRED TO **EXPANDED METAL LATH NOT** FASTENED TO WALL THREE COAT STUCCO 1/2" PLYWOOD SURE CAVITY™ (SC 5016 OR SC 5032) 2 LAYERS ASPHALT IMPREGNATED GRADE "D" CONSTRUCTION PAPER CODE **CONTROL JOINT** REQ'D. WRB SELF FURRING EXPANDED METAL LATH THREE COAT STUCCO CONTROL JOINT WIRED TO EXPANDED METAL LATH NOT FASTENED TO WALL **FRAMING**

HORIZONTAL CONTROL JOINT IN THREE-COAT STUCCO INSTALLATION



SIDING SECTION

SCALE: 0' - 3/4" = 1' - 0"

COMPOSITE SHINGLES. REF. ROOF PLAN FOR LOCATION ZIP WALL T.O. PLATE ---5/8" GYPSUM BOARD - MUSEUM FINISH BLOCKING FOR SHEETROCK FOR TOP PLATE INFORMATION REFER TO SHEETS A2.1 & A.2.2 —OPEN CELL FOAM INSULATION STUCCO-7/16 " ZIP WALL----5/8" GYPSUM BOARD - MUSEUM FINISH **EXTERIOR INTERIOR ENERGY SEAL REQUIRED** 2X6 @ 16" O.C. CONSTRUCTION. TYP. UNO. G.C. TO SELECT WOOD FLOOR 1-1/8 FLOOR DECK - WEATHER PROOF STUCCO-7/16 " ZIP WALL-T.O. 2ND FLOOR **REF. ENGINEERING** T.O. PLATE 2X6 DOUBLE TOP PLATE -5/8" GYPSUM BOARD - MUSEUM FINISH BLOCKING FOR SHEETROCK FOR TOP PLATE INFORMATION REFER TO SHEETS A2.1 & A.2.2 OPEN CELL FOAM INSULATION ---5/8" GYPSUM BOARD - MUSEUM FINISH 7/16 " ZIP WALL-**INTERIOR ENERGY SEAL REQUIRED** -2X6 @ 16" O.C. CONSTRUCTION. TYP. UNO. ----5/8" GYPSUM BOARD - MUSEUM FINISH —ANCHOR BOLT STUCCO-FLOORING PER FINISH PLANS 7/16 " ZIP WALL-T.O. 1ST FLOOR **CONTINUOUS 1X12**

ヒンノ

PIERS AS NEEDED— PER ENGINEER

SCALE: 0' - 3/4" = 1' - 0"

TYPICAL WALL SECTION DETAIL

SAND CUSHION

SLAB SPEC PER ENGINEERING

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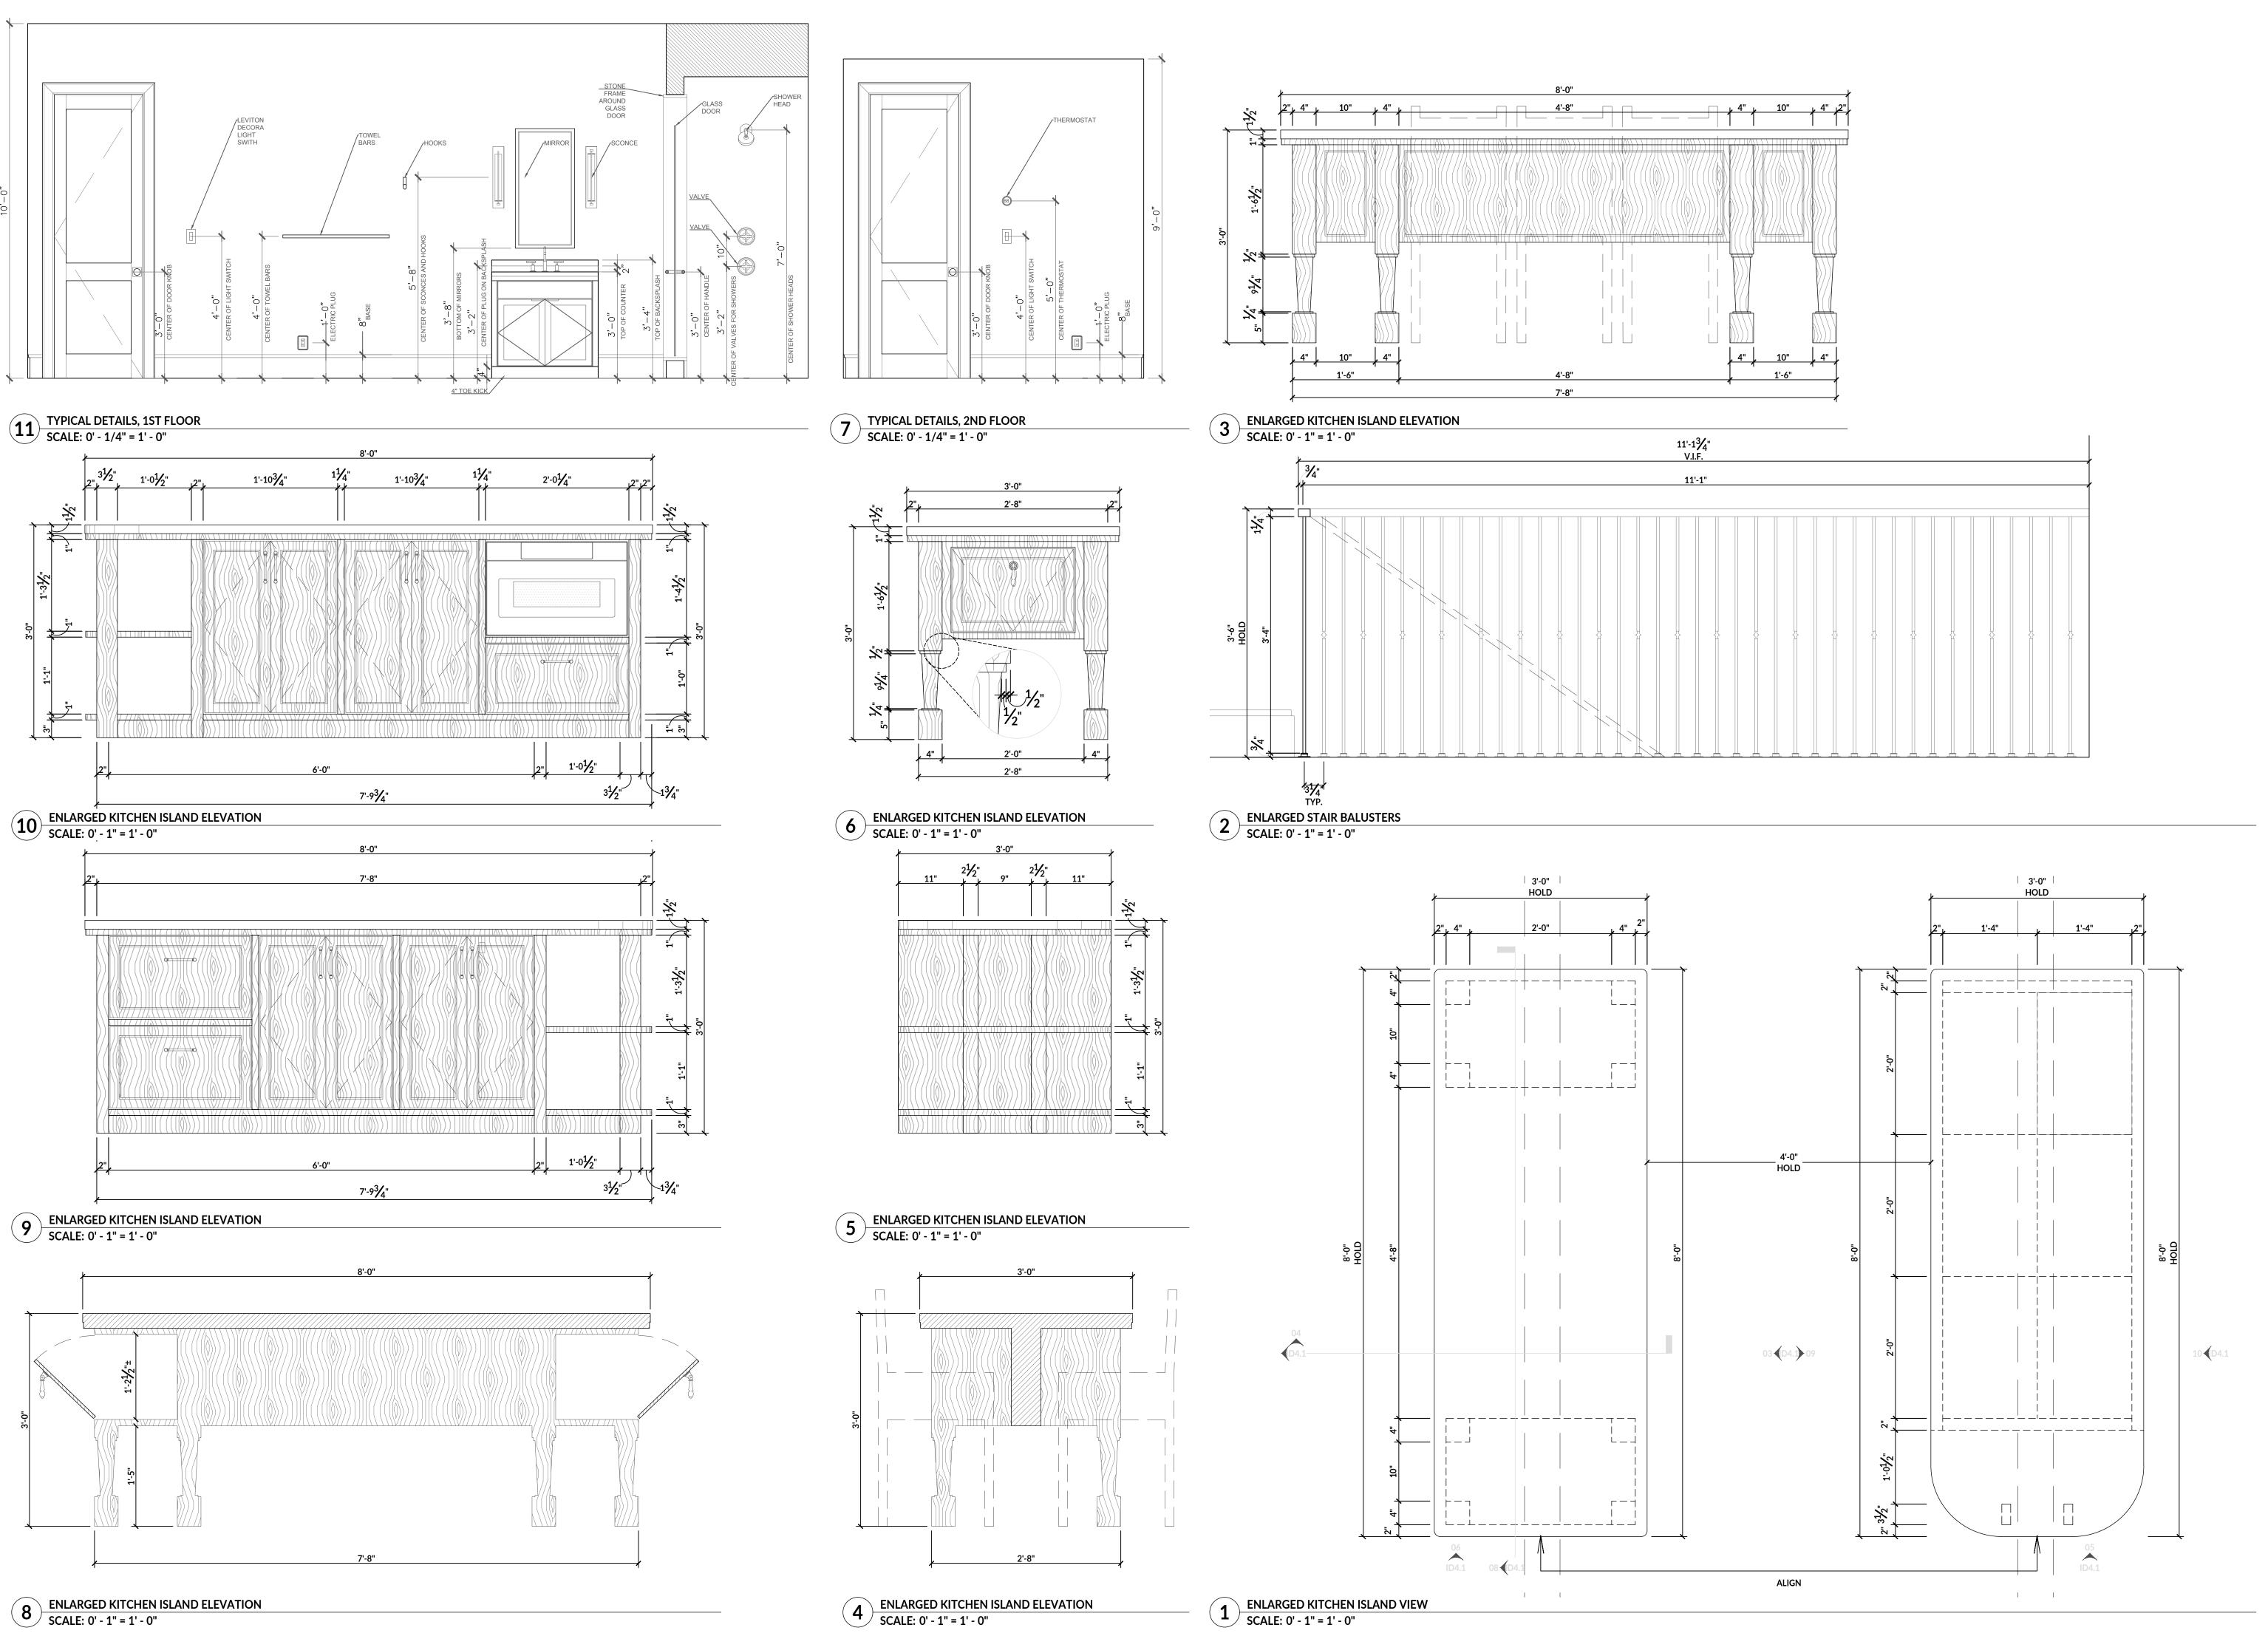
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SECTION DETAILS



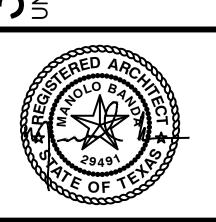
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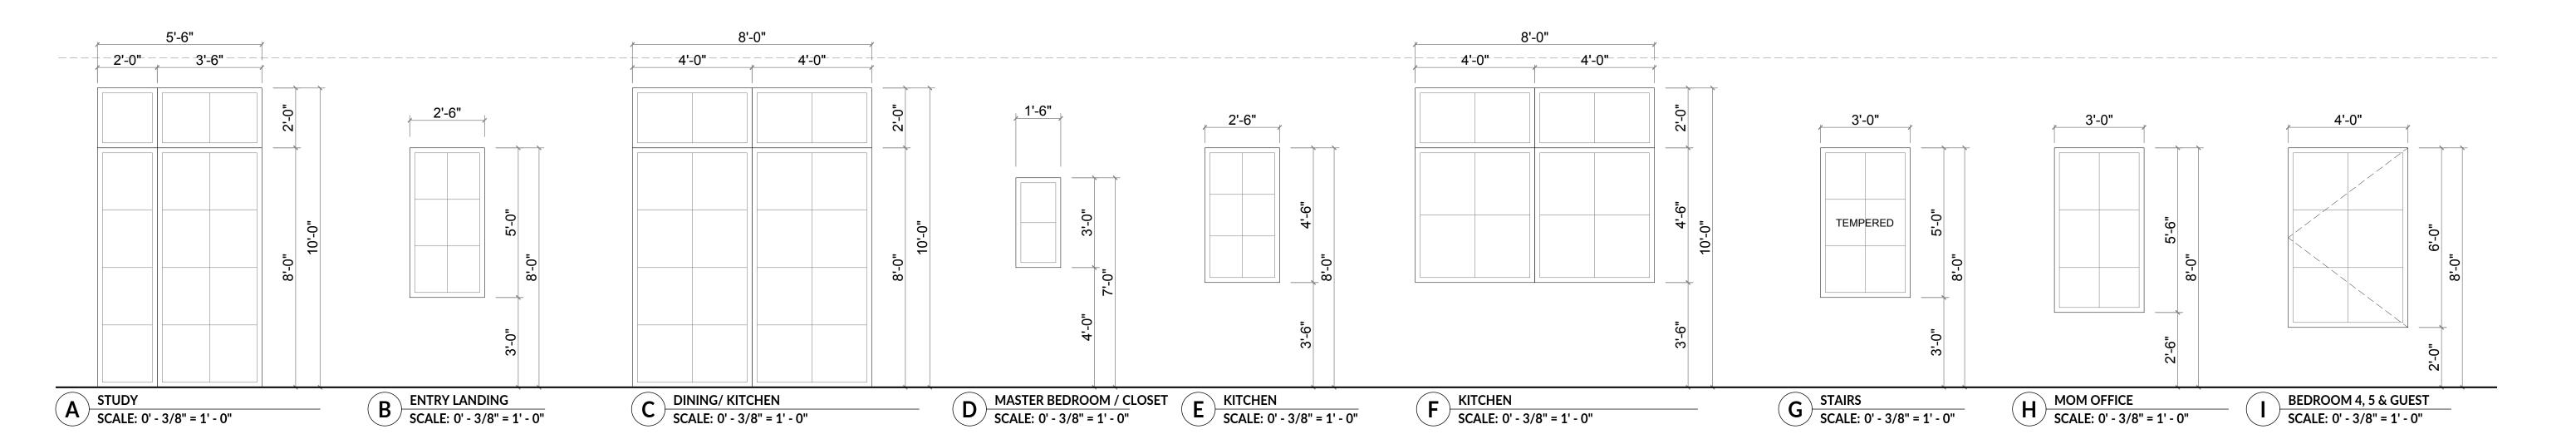
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ENLARGED DETAILS

As indicated

A4.1

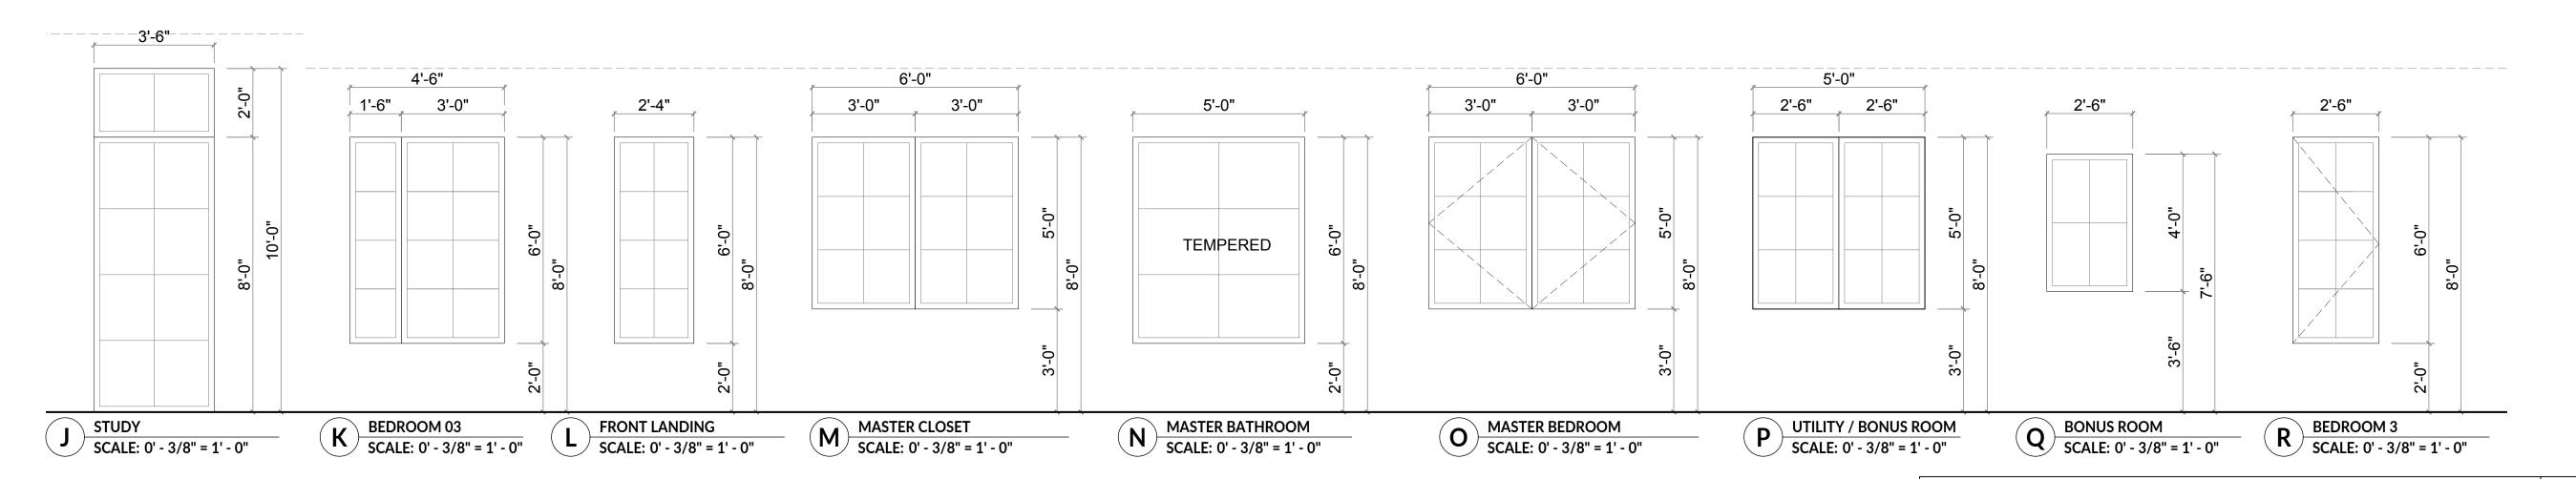


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8'-8"		<u> </u>	12'	-0"			6'-0"	
2'-6" 3'-0"	2'-6"	3'-0"	3'-0"	3'-0"	3'-0"		3'-0" 3'-0"	8'-0"
	"0-'8"					8'-0"	08	

X 3 - GARAGE DOOR, ALL HRDW. INCLUDED

DOOR SCHEDULE

SWING PAIR 8'-8" 8'-0"

12'-0" 8'-0"

6'-0" 8'-0"

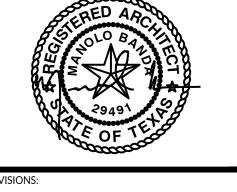
18'-0" 8'-0"

| x |

| x |

INDOW	WINDO	W SIZE	REMARKS		WINDOW T	YPE			FRAME TYPE		NOTES
	WIDTH	HEIGHT	MARVIN OR EQUIVALENT	Tempered Glass	Casement	Single Hung	Fixed	Wood Clad	Aluminum	Fiberglass	
Α	5'-6"	10'-0"			Х			X			
В	2'-6"	5'-0"			Х			X			
С	8'-0"	10'-0"			Х			Х			
D	1'-6"	3'-0"			Х			Х			
E	2'-6"	4'-6"			Х			Х			
F	8'-0"	6'-6"			Х			Х			
G	3'-0"	5'-0"		X	X			X			
Н	3'-0"	5'-6"			X			X			
1	4'-0"	6'-0"			Х			Х			
J	3'-6"	10'-0"			X			Х			
K	4'-6"	6'-0"			X			X			
L	2'-4"	6'-0"			X			Х			
M	6'-0"	5'-0"			X			X			
N	5'-0"	6'-0"		X	X			X			
0	6'-0"	5'-0"			Х			X			
Р	5'-0"	5'-0"			X			X			
Q	2'-6"	4'-0"			X			X			
R	2'-	6'-			X			X			

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PROJECT NO:

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PROJECT ISSUE DATE:
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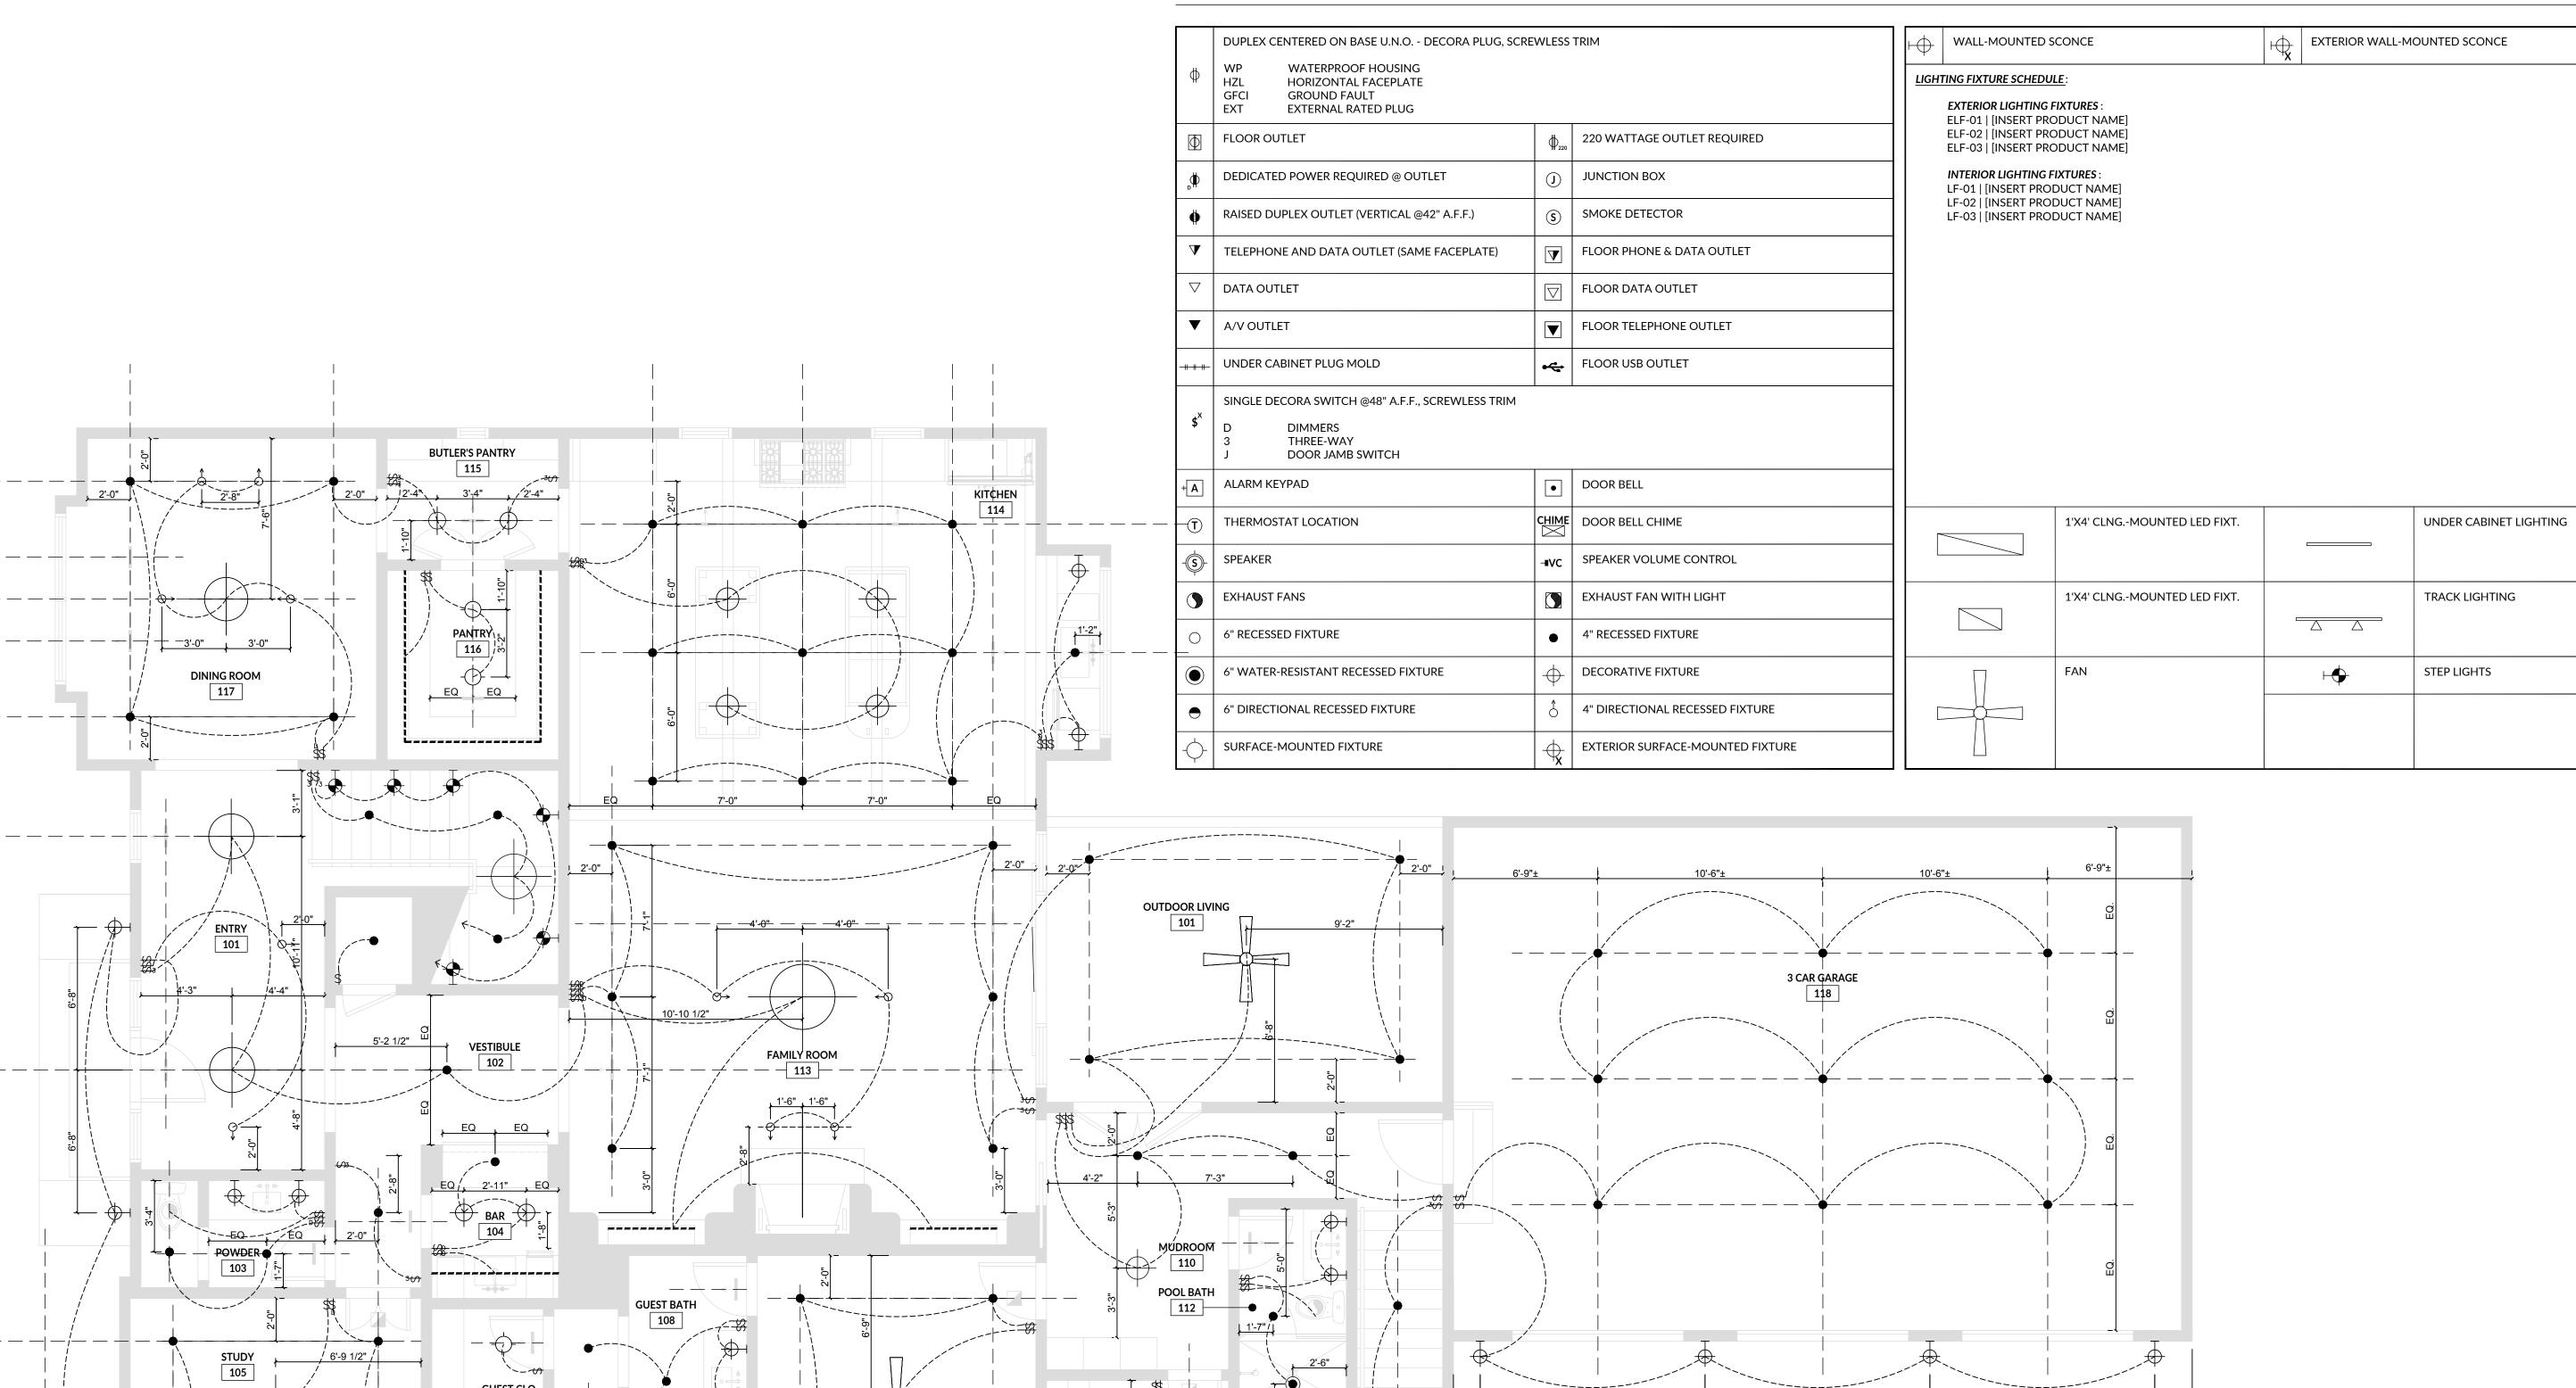
WINDOW & DOOR SCHEDULE

SCALE:

As indicated

DRAWING NUMBER:

A6.1



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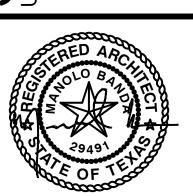
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PROJECT ISSUE DATE:	23.06.28
DRAWING TITLE	

1ST FLOOR LIGHTING PLAN

As indicated

STORAGE 106

ELECTRICAL & POWER LEGEND

, EQ , EQ ,

LAUNDRY ROOM

REAR LANDING

CLOSET 4

MASTER BEDROOM

HIS BATH \

MASTER CLOSET

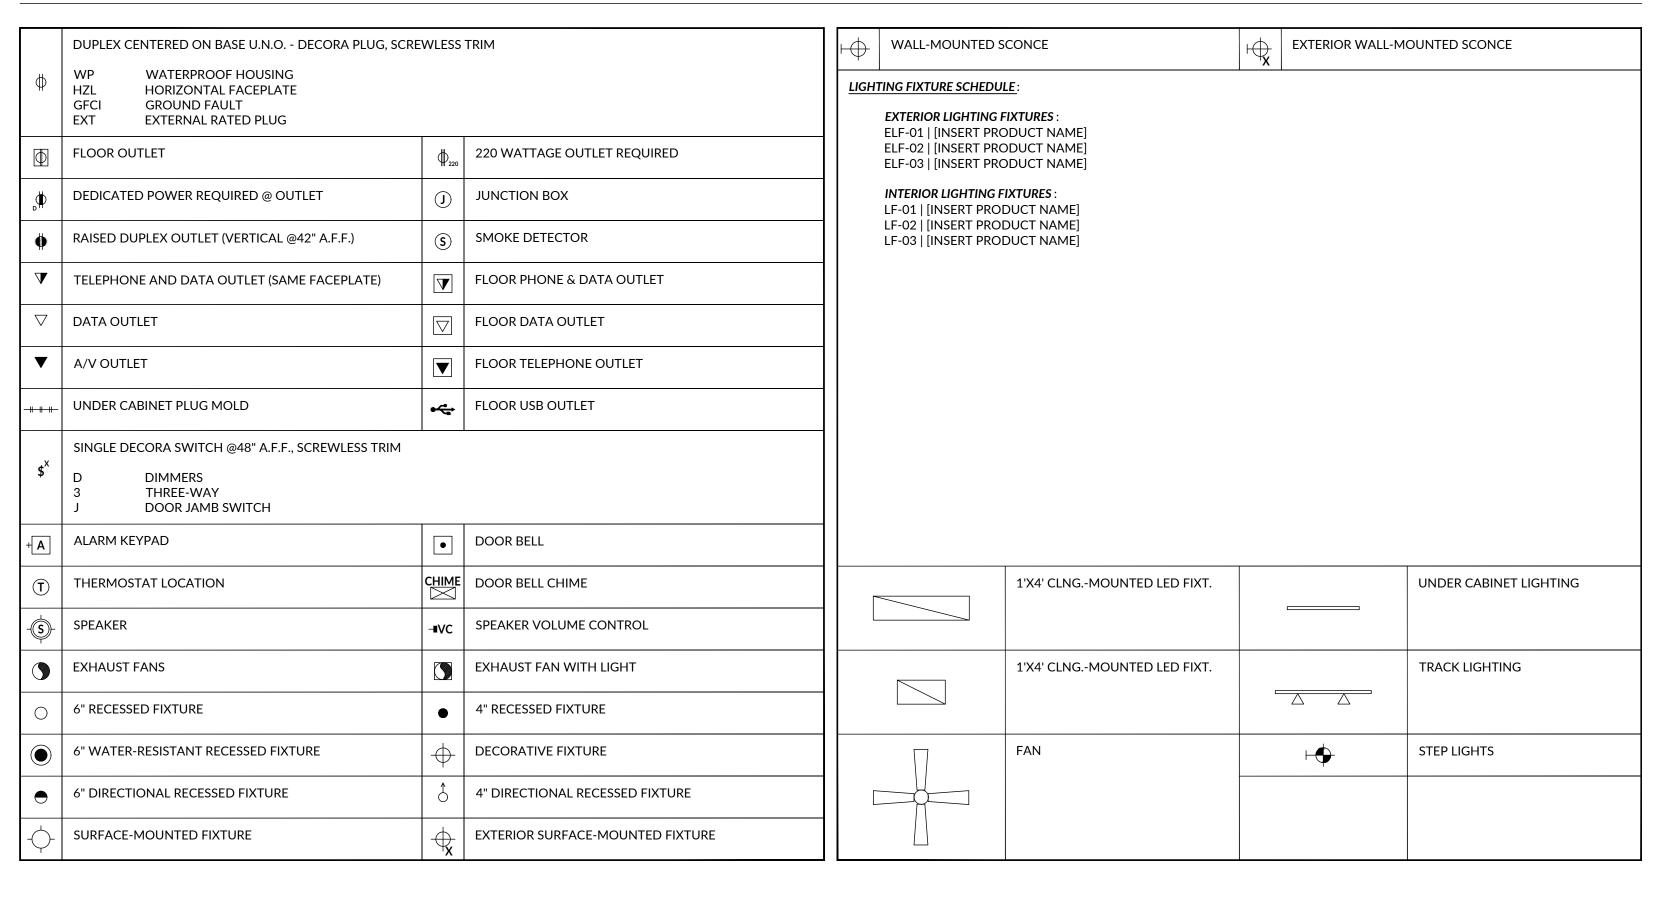
FRONT LANDING
201

BEDROOM 3

HER BATH

216

BEDROOM 5



BONUS ROOM

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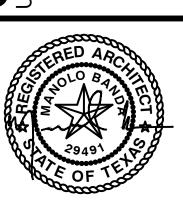
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2ND FLOOR LIGHTING PLAN

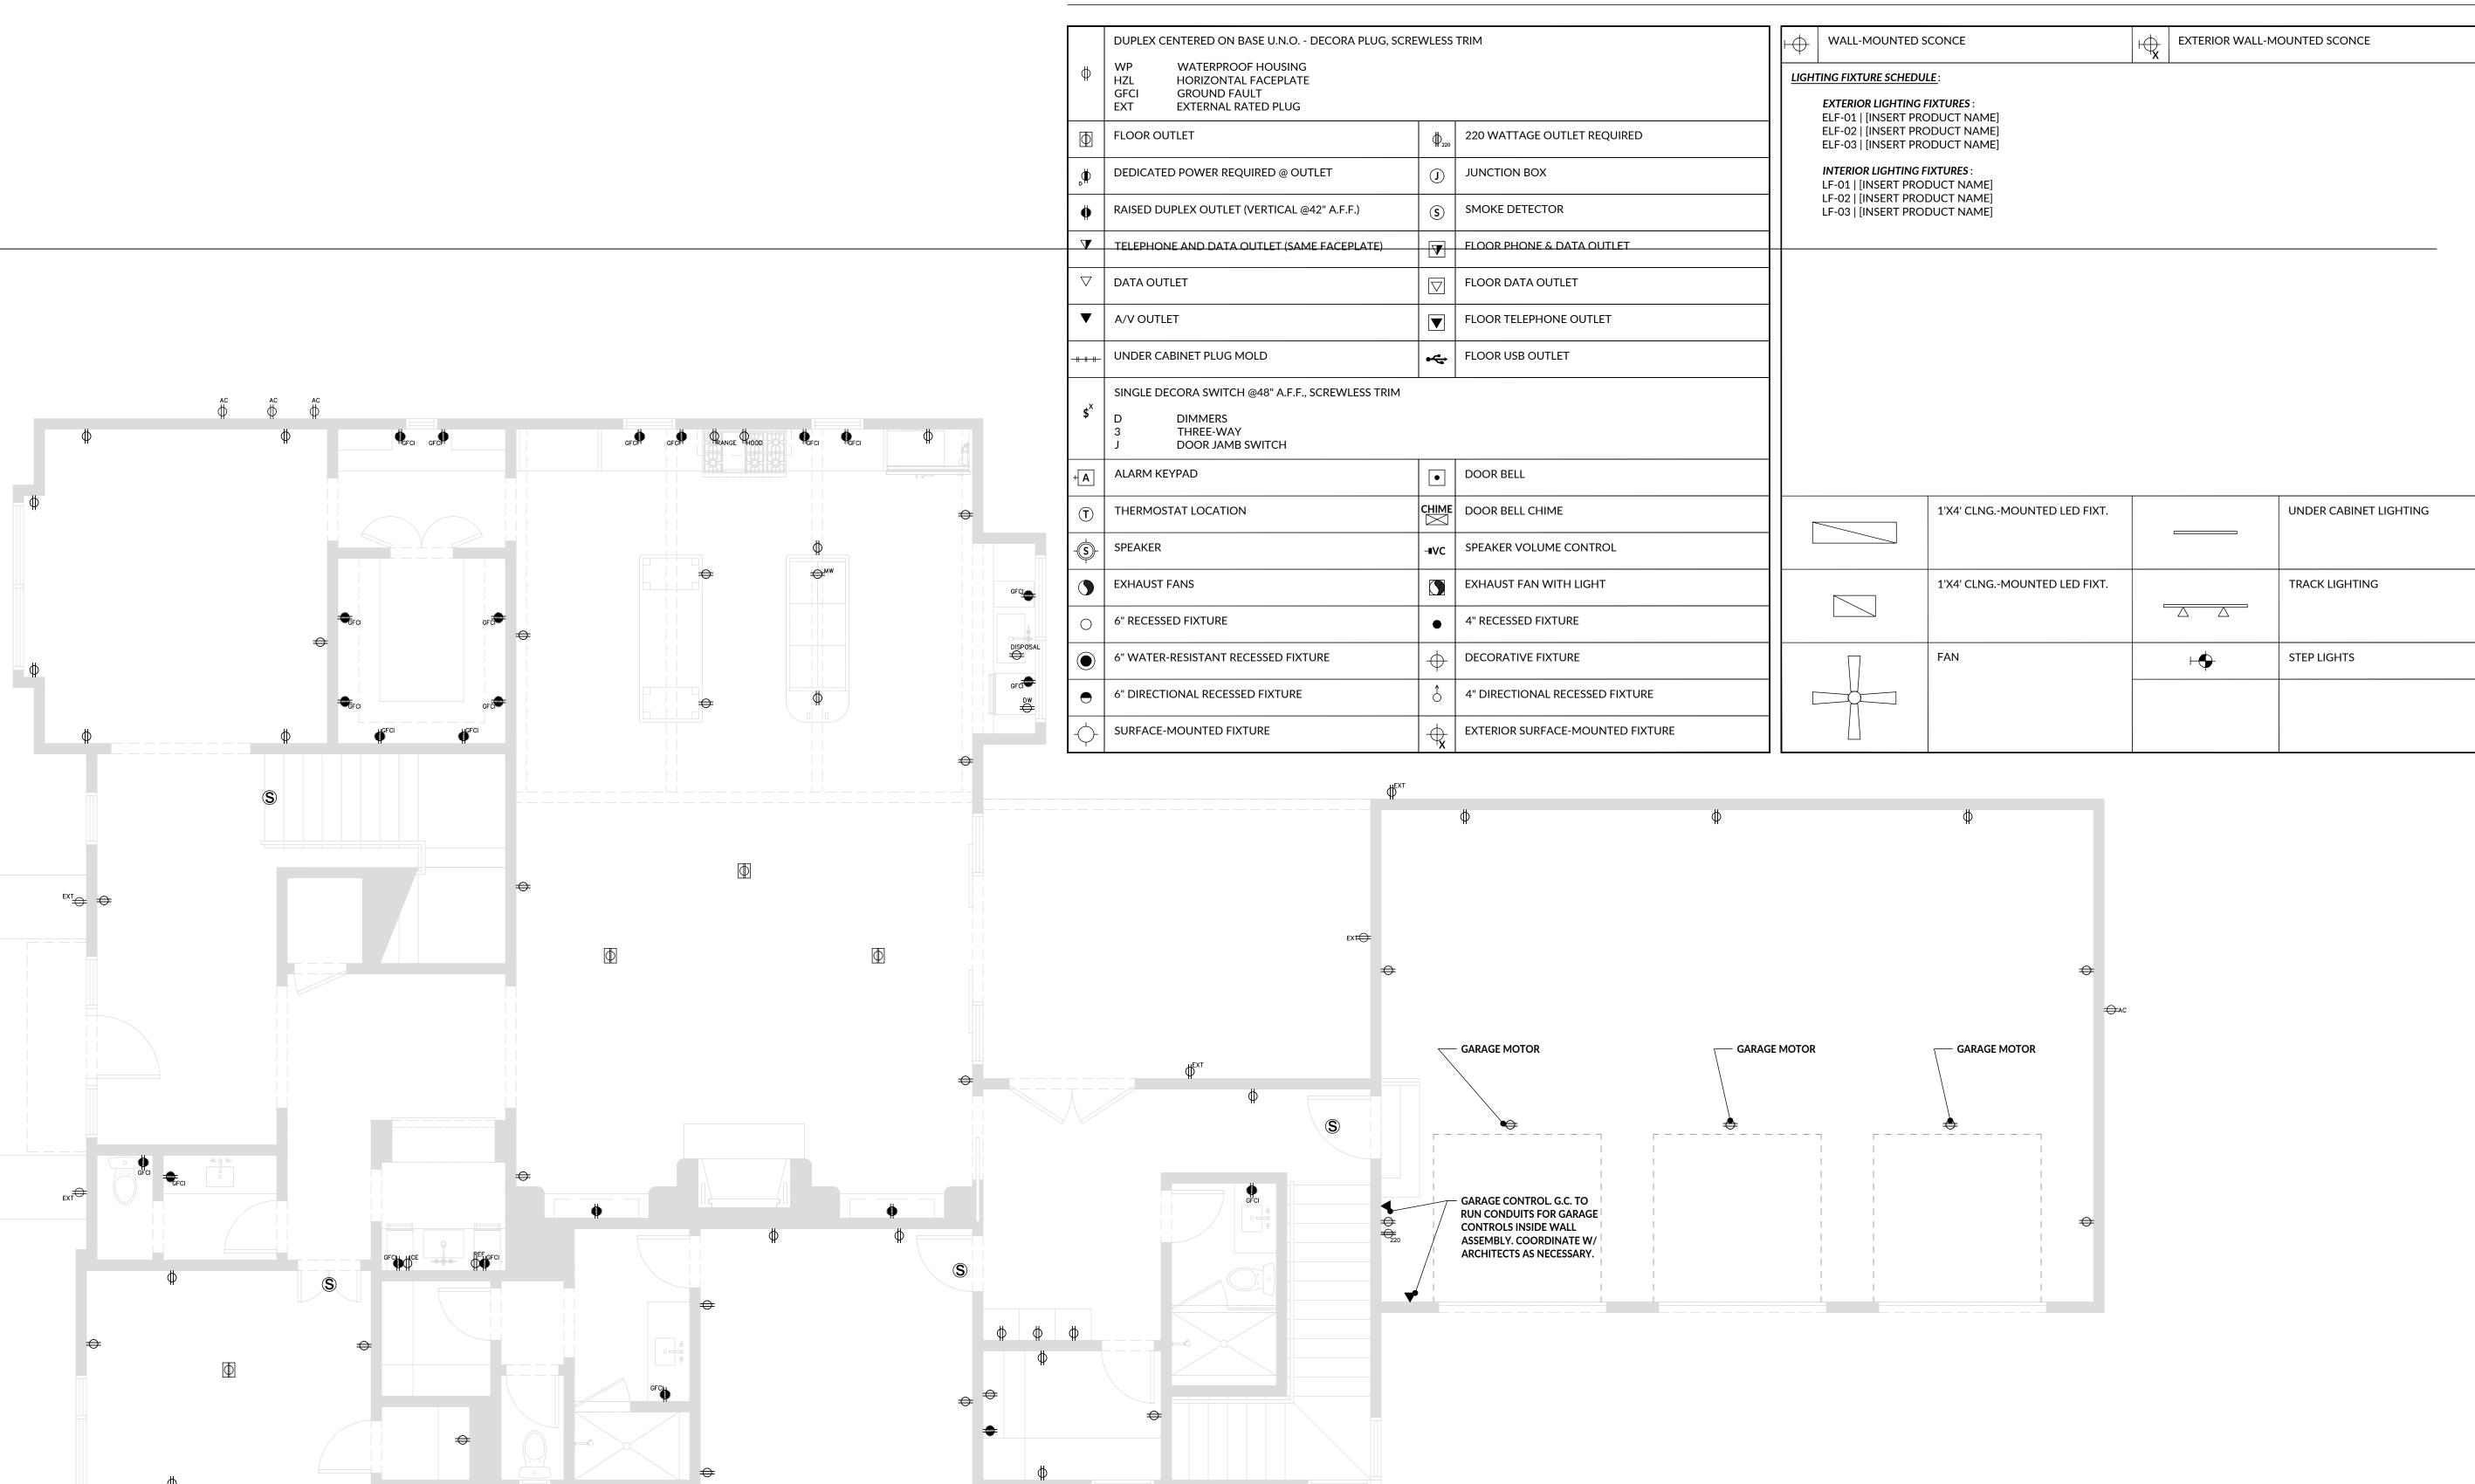
SCALE:
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E1.2

01 2ND FLOOR LIGHTING PLAN
SCALE: 0' - 1/4" = 1' - 0"

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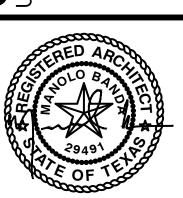
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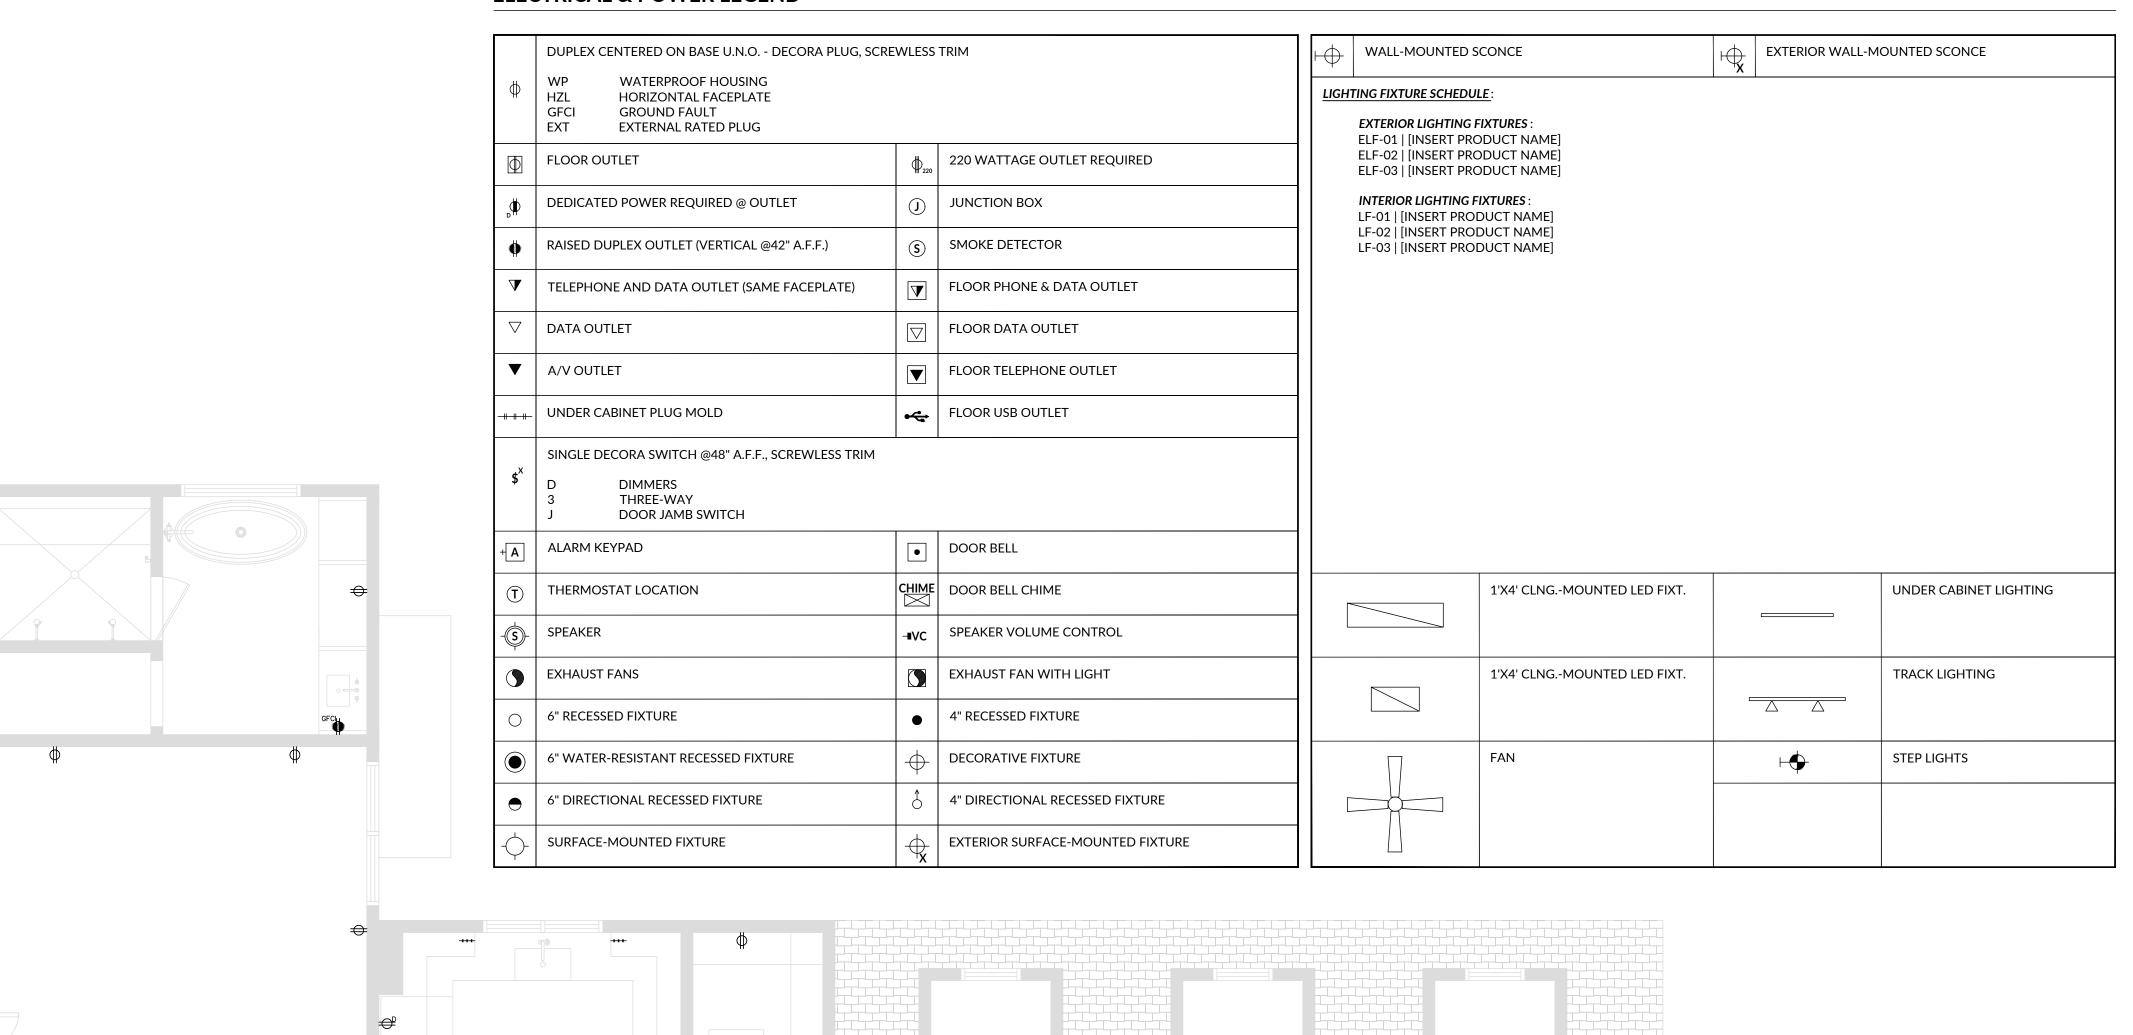
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	DRAWING TITLE:

1ST FLOOR POWER PLAN



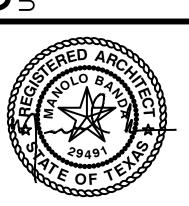
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2ND FLOOR POWER PLAN

SCALE:
As indicated

E1.4