CONSTRUCTION. CONFLICTS W/ CONTRACTORS STANDARD PRACTICE NEED TO BE BROUGHT TO THE ATTENTION OF MANOLO DESIGN STUDIO LLC & OWNER. CONTRACTOR TO CONFORM TO ALL 24. ALL PERMITS AND FEES SHALL BE THE APPLICABLE BUILDING CODES, APPLY FOR ALL PERMITS RESPONSIBILITY OF THE CONTRACTOR. AND INSPECTIONS TO COMPLETE WORK AS PER CITY AND UNIFORM BUILDING CODES. 25. CONTRACTOR SHALL SCHEDULE AND

2. CONTRACTOR/OWNER ALTERATIONS OR SUBSTITUTIONS TO THE PLANS ARE THE RESPONSIBILITY OF THE CONTRACTOR/OWNER TO TO BE PRESENT IF DESIRED. COORDINATE W/ THE RELEASED DOCUMENTS.

3. ENERGY CALCULATIONS SHALL BE CONDUCTED BY A THIRD PARTY RECOGNIZED BY THE GOVERNING BODY TO DO SUCH SERVICES.

4. ENERGY TESTING SHALL BE CONDUCTED BY A FIXTURES AND FINISHES. ARCHITECT DOES NOT SELECT.

THE CONTRACTOR SHALL INFORM ARCHITECT DIMENSIONS ARE ACCURATELY NOTED.

TO THE CONTRACTOR SHALL INFORM ARCHITECT DIMENSIONS ARE ACCURATELY NOTED. THIRD PARTY RECOGNIZED BY THE GOVERNING BODY

5. FOUNDATION SHALL ADHERE TO DESIGN PROVIDED BY STRUCTURAL ENGINEER. STRUCTURAL

ALTERNATES WILL BE ALLOWED WITHOUT PRIOR STRUCTURAL ENGINEER BEFORE DEMOLITION OF ANY

7. METAL, VINYL, OR ADHESIVE FLASHING SHALL BE DRAWINGS INCLUDED IN THIS SET TO ONLY INDICATE APPROVAL OF THE DESIGNER. THE DIMENSIONAL GUIDELINES TO LAYOUT THE FOUNDATION AND SHOULD BE COORDINATED W/ ARCHITECTURAL SET. AFTER AN AWARD OR CONTRACT.

6. HEATING AND COOLING SYSTEM SHALL BE DESIGNED BY INSTALLER. SUPPLY AND RETURN VENTS SHALL ALIGN WITH LIGHT OR CENTER ON WALLS AND PROJECT, SUCH PROPOSALS SHALL INCLUDE THE COST FROM DAMAGE DUE TO CONSTRUCTION AND CABINETRY NOTES CEILING AREAS. THERMOSTATS SHALL BE LOCATED OF REVISIONS REQUIRED BY THE DESIGN AND/OR DEMOLITION. THE CONTRACTOR SHALL BE CENTRALLY 10" FROM JAMB OF ADJACENT DOOR TO AVOID CONFLICT WITH FURNISHINGS & TRIM.

7. DO NOT SCALE THE DRAWINGS. CONTACT THE ARCHITECT TO VERIFY ANY DIMENSIONS THAT ARE NOT INDICATED.

8. ALL CONSTRUCTION TO COMPLY WITH APPLICABLE BUILDING CODES AND REGULATED AMENDMENTS AND ANY OTHER LAWS, ORDINANCES, REGULATIONS, OR ANY OTHER BODY HAVING JURISDICTION OVER THE PROJECT.

9. CONTRACTOR SHALL USE HIS BEST EFFORTS, SKILLS, JUDGEMENT, AND ABILITIES WITH RESPECT TO THE CONSTRUCTION OF THE PROJECT. AND FURTHER THE INTERESTS OF THE OWNER IN ACCORDANCE WITH THE HIGHEST PROFESSIONAL STANDARDS AND TO BE PROTECTED FROM DAMAGE AT ALL TIMES. ACCEPTABLE METHODS OF CONSTRUCTION. CONTRACTOR SHALL BE SOLELY RESPONSIBLE FOR CONSTRUCTION MEANS, METHODS, TECHNIQUES, CURRENT CITY CODES SEQUENCES, AND PROCEDURES REQUIRED FOR SAFE EXECUTION AND COMPLETION OF THE WORK.

10. THE CONTRACTOR SHALL BE RESPONSIBLE FOR 2015 INTERNATIONAL MECHANICAL CODE W/ AMD. VERIFYING THE FINISHED BUILDING MEETS OR 2014 NATIONAL ELECTRICAL CODE W/ AMD. EXCEEDS ALL REQUIREMENTS OF THE 2015 IECC, AND 2015 INTERNATIONAL RESIDENTIAL CODE W/ AMD. SHALL BE RESPONSIBLE FOR COMPLETING ASSOCIATED 2015 INTERNATIONAL RESIDENTIAL EXISTING CODE SUBMITTALS TO THE AUTHORITY HAVING 2015 INTERNATIONAL ENERGY CONSERVATION CODE COMPLETE THE DEMOLITION SCOPE OF WORK. REFER JURISDICTION. SHOULD THE FINISHED BUILDING FAIL W/AMD. TO MEET ANY OF THE REQUIREMENTS OF THE 2015 2015 INTERNATIONAL FUEL AND GAS CODE W/ AMD. IECC, THE CONTRACTOR SHALL BE RESPONSIBLE FOR 2015 INTERNATIONAL GREEN CONSTRUCTION CODE INFORMATION. CORRECTING ANY DEFICIENCIES AND RESUBMITTING W/AMD. FOR JURISDICTIONAL REVIEW/ ACCEPTANCE.

11. ANY ERRORS, OMISSIONS, AND INCONSISTENCIES IN DRAWINGS, OR AMBIGUITIES BETWEEN DRAWINGS

REQUIREMENTS AND SITE CONSTRUCTION CONDITIONS. SHALL BE BROUGHT TO THE ATTENTION OF THE ARCHITECT AND/OR THE OWNER. FAILURE TO NOTIFY THE OWNER (NTCOG AMENDED AND THE ARCHITECT IN SUCH AN EVENT WILL CONSTITUTE ACCEPTANCE OF ANY RESULTING INSULATION (MIN OBLIGATIONS OR RESPONSIBILITIES WITH REGARD TO ATTIC: R-36 DELAYS, COST, AND LEGAL REMEDIES RESULTING FROM NO ATTIC: R-30 THIS OR RELATED WORK.

12. CIVIL, STRUCTURAL, MECHANICAL, & LANDSCAPE 2X6 WALLS: R-19 DRAWINGS ARE PROVIDED BY THE OWNER, OR UNDERFLOOR OVER UNCONDITIONED SPACE: R-19 OTHERS AS AUTHORIZED BY THE OWNER

13. CONTRACTOR SHALL BE RESPONSIBLE FOR WINDOWS & GLASS DOORS: U-FACTOR 0.35, SHGC 0.25 OBTAINING AN ACCURATE SURVEY OF THE SKYLIGHTS: U-FACTOR 0.55, 0.25 SHGC PRIOR TO THE POURING OF CONCRETE, WHICH MECHANICAL SYSTEMS (MIN.) CERTIFIES THAT THE STRUCTURE IS WITHIN THE 14 SEER ALLOWABLE BUILDING AREA FOR THE PROJECT. SUPPLY DUCTS IN UNCONDITIONED SPACE: R-6 PROVIDE ONE COPY EACH TO OWNER & ARCHITECT. RETURN DUCTS IN UNCONDITIONED SPACE: R-6

14. EXACT SIZE AND REINFORCEMENT OF ALL HOT WATER PIPING: R-3 CONCRETE WORK SHALL BE ACCORDING TO RECOMMENDATIONS FROM THE ENGINEERED SOILS LIC REPORT (PROVIDED BY THE OWNER), AND ACCEPTABLE 75% OF THE PERMANENTLY INSTALLED LIGHT FIXTURES PRACTICES OF CONSTRUCTION.

15. CONTRACTOR SHALL VERIFY WITH OWNER ALL INTERIOR AND EXTERIOR FINISHES PRIOR TO FRAMING NOTES PURCHASING AND INSTALLATION.

16. ATTIC AND CRAWLSPACE (IF ANY) VENTILATION NOT RELIEVE THE CONTRACTOR OF MEETING ALL OF SHALL COMPLY WITH LOCAL CODES.

17. ONCE BUILDING IS ENCLOSED WITH FINISHES, NO TO FAMILIARIZE THEMSELVES WITH ALL APPLICABLE FOOD OR DRINK SHALL BE ALLOWED IN BUILDING. 18. KEEP DIRT TO A MINIMUM - WALK OFF MATS CURRENT BUILDING CODE.

CAUSED BY ARCHITECT'S SOLE NEGLIGENCE.

GYPSUM ASSOCIATION

APA - ENGINEERED WOOD ASSOCIATION

WESTERN WOOD TRUSS ASSOCIATION

CONCRETE BLOCK ASSOCIATION

NATIONAL TILE CONTRACTORS ASSOCIATION

STEEL STUD MANUFACTURERS ASSOCIATION

RESIDENTIAL CODE (IRC), 2015 EDITION. 19. THE CONTRACTOR AND SUBCONTRACTORS SHALL 3. ALL WOOD FRAMING AND ERECTION SHALL BEFORE ROUGH-IN. BE IN CONTROL OF THE PROJECT SITE AND SOLELY CONFORM TO THE NATIONAL DESIGN SPECIFICATION 3. WINDOWS NOTED ON PLANS NEED TO BE 10. VERIFY RANGE VENT POWER REQUIREMENTS RESPONSIBLE FOR CONSTRUCTION MEANS AND FOR WOOD CONSTRUCTION BY THE NFPA, THE VERIFIED BY FRAMER BEFORE FRAMING TO MAKE SURE WITH THE SUPPLIER. METHODS, SCHEDULING, SEQUENCING, JOBSITE PLYWOOD DESIGN SPECIFICATION BY THE APA AND WINDOWS ORDERED, AND CURRENT MANUFACTURERS 11. ALL EXTERIOR CONVENIENCE OUTLETS TO BE SAFETY. AND COMPLIANCE WITH CONTRACT SHALL MEET THE REQUIREMENTS OF THE IRC. ALL DIMENSIONS ARE ACCURATELY NOTED.

ACCORDINGLY, ALL CONTRACTORS AND WITH THE FASTENING SCHEDULE OF THE IRC. SUBCONTRACTORS ARE REQUIRED TO DEFEND, 4. ALL FRAMING LUMBER SHALL BE NO.2 OR DIMENSIONS EGRESS REQUIREMENTS IN ALL SLEEPING 13. PLAN LAYOUT IS A GENERAL SUGGESTION INDEMNIFY, AND HOLD HARMLESS OWNER AND BETTER SOUTHERN PINE. ALL STUD WALLS AND ROOMS. ARCHITECT FROM ANY AND ALL CLAIMS, LOSSES, SUITS, PARTITIONS ARE 2X6 @ 16" O.C. UNLESS OTHERWISE 5. WOOD STUD WALLS 2X4'S @ 16" O.C. TO ARCHITECT/DESIGNER. DAMAGES, AND LIABILITIES, INCLUDING ATTORNEYS' NOTED (REF. ENGINEER DWGS.). ALL PLUMBING WALLS

MAXIMUM HEIGHT OF 11 OR 12 FEET SUPPORTING ONE

14. ALL SCONCES TO BE PLACED AT 68" AFF UNLESS FEES AND COSTS, ARISING IN ANY WAY FROM SUCH ARE 2X6 @ 16" O.C. BLOCK ALL STUD WALLS AT MID FLOOR, ROOF, AND CEILING. WALL HEIGHTS NOTED OTHERWISE CONTRACTORS' OR SUBCONTRACTORS' SERVICES OR HEIGHT. WORK PRODUCT, EXCEPT TO THE EXTENT CAUSED BY

5. ALL LUMBER IN CONTACT WITH CONCRETE OR

TO DETERMINE STUD SIZE AND SPACING. ALL FLOOR

OWNER/ARCHITECT/DESIGNER.

ARCHITECT'S SOLE NEGLIGENCE. IN SUPPORT OF THIS MASONRY SHALL BE TREATED. RAMSET BOTTOM PLATE PLAN ANGLES ARE 90 OR 45 DEGREES UNLESS 16. CENTER HANGING FIXTURES IN THE SPACE, OBLIGATION, CONTRACTORS AND SUBCONTRACTORS OF STUD WALLS TO CONCRETE WITH 1/4" RAMSETS @ OTHERWISE NOTED. EXTERIOR WALLS, WALLS WITH UNLESS NOTED OTHERWISE SHALL INCLUDE OWNER AND ARCHITECT AS 16" O.C., EXTERIOR BASE PLATES SHALL BE ADDITIONAL INSURED UNDER ITS INSURANCE POLICIES ANCHORED @ 24" O.C. W/ MIN 1/2 X 10", MIN SHALL BE 2X6 STUDS. APPLICABLE TO THE PROJECT. ARCHITECT SHALL NOT EMBEDMENT OF 8", ANCHOR BOLTS USING 3"X3" 6. VENT CLOTHES DRYER AND ALL KITCHEN & WITH BUILDER/OWNER BEFORE PULLING WIRE FOR BE RESPONSIBLE FOR DAMAGES, LOSSES, COSTS, OR WASHER. ONE ANCHOR BOLT SHALL BE WITHIN 6" TO BATHROOM EXHAUST FANS TO OUTSIDE. CLAIMS CAUSED BY CONTRACTORS OR 12" OF EACH PLATE AND WITHIN 12" OF ALL CORNERS. 7. CLEAN INSIDE ALL WALLS @ BASE TRACK W/ 18. CONTRACTOR SHALL SIZE ELECTRICAL SYSTEM SUBCONTRACTORS, EXCEPT ONLY TO THE EXTENT PROVIDE HOLD DOWN ANCHORS @ ENDS OF ALL VACUUM PRIOR TO CLOSING WALLS SHEAR PANELS/WALLS. ALSO SEE NOTE 12. 20. ARCHITECT SHALL BE ENTITLED TO RELY ON THE BRACING SHALL BE PROVIDED PER BUILDING CODE. EXISTING PLANS. NOTIFY ARCHITECT OF ANY PROPOSED TO THE OWNER PRIOR TO PURCHASING ADEQUACY AND ACCURACY OF INFORMATION PROVIDE DOUBLE JOIST AT ALL STUD WALLS PARALLEL DISCREPANCIES.

PROVIDED BY OWNER OR OWNER'S CONSULTANTS. TO FRAMING BELOW. ARCHITECT SHALL COORDINATE SUCH INFORMATION 7. GABLE ENDS TO BE BUILT SIMILAR TO AND LOCATIONS WHERE NATURAL OR STAINED WOOD SOLELY FOR INTERFACE WITH ITS SERVICES AND SHALL CONNECTED WITH WALL STUDS BELOW. BRACE GABLE FINISH IS VISIBLE. STAINED WOOD FINISH FLOORING NOTIFY OWNER OF ANY ERRORS ACTUALLY IDENTIFIED ENDS AGAINST LATERAL LOADS. IN SUCH INFORMATION. ARCHITECT SHALL NOT BE 8. PROVIDE APA RATED 4'X8'X1/2" PLYWOOD 10. ALL GWB SHALL BE 5/8" THICK UNO.

RESPONSIBLE FOR THE ACTS OR OMISSIONS OF THE WIND BRACING ON ALL EXTERIOR WALLS FROM SLAB 11. JOINTS ABUTTING EXISTING WALLS ARE TO BE OWNER, CONTRACTORS, OTHER CONSULTANTS AND TO THEIR RESPECTIVE AGENTS OR EMPLOYEES, OR ANY UNDERSIDE OF RAFTERS.

THE PROJECT WHO ARE NOT UNDER THE DIRECT MANUFACTURED BY SIMPSON STRONG TIES CO OR EQUIV. INSTALL IN STRICT ACCORDANCE WITH THE 13. INTERIOR PARTITION WALLS ARE FRAMED WITH MANUFACTURER'S SPECIFICATIONS. USE JOIST 21. ALL GENERAL CONDITIONS, SPECIAL HANGERS FOR JOIST AND BEAMS WHICH FRAME TO 14. REFER TO POCKET DOOR FRAME KIT FOR REQUIREMENTS OR GENERAL REQUIREMENTS OF THE BEAMS AT THE SAME ELEVATION. JOIST HANGERS CONSTRUCTION SPECIFICATIONS OF MATERIAL SHALL BE SAME SIZE AS THE MEMBER SUPPORTED.

48/24, 3/4" THICK TONGUE & GROOVE. 22. ALL WORK SHALL BE IN ACCORDANCE WITH INDUSTRY STANDARDS. INDUSTRY STANDARDS SHALL AT UNSUPPORTED EDGES BETWEEN ROOF RAFTERS.

13. 2., 3. 1. 1. ROOF SHEATHING SHALL BE OSB. PROVIDE CLIPS AT UNSUPPORTED EDGES BETWEEN ROOF RAFTERS.

14. ROOF PLAN NOTES BE AS DETERMINED BY MANUAL OR HANDBOOK OF NAILS TO BE EITHER 8D COMMON OR 10D BOX NAILS. THE PRIMARY ASSOCIATION OF EACH TRADE. THE MAXIMIZE SPACING FOR SHEATHING NAILING MANUALS SHALL INCLUDE, BUT NOT BE LIMITED TO: O.C. WITHIN 4' OF EXTERIOR WALLS, RIDGES OR HIPS WORK TO 6 AT SHEATHING EDGES AT EACH RAFTER.

SOLID BLOCKING OVER GABLE STUD TOP PLATE.

23. SHOP DRAWINGS OR DRAWINGS PROVIDED BY TOP OF BOTTOM EDGES OF JOIST, NOT LARGER THAN 1 WALL. OTHERS ARE NOT PART OF THE CONTRACT 1/4" DIA AND NOT IN THE MIDDLE OF A SPAN. 4. ADDITIONAL STRIP OF FULLY-ADHERED DOCUMENTS BUT SHALL BE PREPARED IN 13. ALL STUDS CUT AWAY FOR PLUMBING SHALL BE ROOFING MEMBRANE TO BE APPLIED AT ALL ACCORDANCE WITH THE CONTRACT DOCUMENTS AND STRAPPED WITH 1 1/2" WIDE, NO. 24 GAUGE ROOF-WALL INTERSECTIONS EXTENDING MIN. 12" THE BUILDER SHALL CERTIFY THE SHOP DRAWINGS. AND SPIKED TO PLATES.

OWNER SHALL BE NOTIFIED IN ADVANCE OF

MATERIALS AND LABOR FOR EACH ITEM.

2015 INTERNATIONAL BUILDING CODE W/ AMD.

2015 INTERNATIONAL PLUMBING CODE W/ AMD.

2X4 WALLS: R-13+3 (R-13 CAVITY + R+3 INSULATING

SHEATHING)

REFRIGERANT PIPING: R-3

EFFICIENCY LAMPS (CFL OR LED)

TO HAVE HIGH

INCLUDE ALL TRADES AFFECTED.

14. ALL FRAMING SHALL BE COORDINATED WITH HVAC DUCTS, ELECTRICAL AND PLUMBING ELEVATION NOTES REQUIREMENTS.

25. CONTRACTOR SHALL SCHEDULE AND COORDINATE ALL INSPECTIONS. DESIGNER AND DEMOLITION NOTES

THE NATURE OF THE DEMOLITION PLANS IS TO ADJACENT WALL COLOR. INSPECTIONS TO ENABLE THE DESIGNER AND OWNER 1. IDENTIFY THE GENERAL NATURE OF DEMOLITION 3. ALL STOREFRONT MULLIONS ARE 2" NOMINAL SCOPE. THE CONTRACTOR IS RESPONSIBLE FOR UNLESS NOTED OTHERWISE. 26. ALL MATERIALS SHALL BE NEW UNLESS VISITING THE SITE AND VERIFYING THE EXISTING 4. ALL GLAZING IS LOW "E" UNLESS NOTED CONDITIONS. 2. THE CONTRACTOR SHALL COORDINATE ALL 5.

27. IT IS THE INTENT OF THE ARCHITECT TO PROVIDE DEMOLITION SCOPE OF WORK WITH NEW VERIFIED BY FRAMER BEFORE FRAMING TO MAKE SURE FLEXIBILITY TO THE OWNER IN THE SELECTION OF CONSTRUCTION. SPECIFIC MANUFACTURERS OF PRODUCTS OR OF ANY DISCREPANCIES ASSOCIATED WITH 6. WINDOWS SPECIFIED NEED TO BE CHECKED BY FIXTURES UNLESS SUCH PRODUCT HAS A SPECIFIC DEMOLITION SCOPE OF WORK AND NEW CONTRACTOR TO BE SURE CURRENT MANUFACTURING DESIGN REQUIREMENT OR INTENT. WHERE A SPECIFIC CONSTRUCTION.

PRODUCT IS SPECIFIED, NO SUBSTITUTIONS OR 4. THE CONTRACTOR SHALL CONSULT WITH ROOMS. STRUCTURAL MEMBERS. THE CONTRACTOR SHALL INSTALLED AT HORIZONTAL WOOD TRIM, OPENINGS, PROVIDE ALL TEMPORARY STRUCTURAL BRACING AND TERMINATIONS OF SIDING. EXPOSED FLASHING 28. VALUE ENGINEERING MAY TAKE PLACE ONLY NECESSARY DURING DEMOLITION AND SHALL BE PAINTED TO MATCH ADJACENT TRIM.

THE CONTRACTOR SHALL PROTECT ALL VENTING SHALL BE OUT OF SIGHT FROM FRONT & 29. WHEN A CONTRACTOR PROPOSES METHODS OF EXISTING FINISHES, DOORS, FRAMES, AND WINDOWS REAR ELEVATION IF POSSIBLE. ENGINEERS. THE FEES INCURRED BY THE DESIGNER RESPONSIBLE FOR REPLACING/REPAIRING ANY AND/OR ENGINEER SHALL BE PAID FOR BY THE DAMAGED FINISHES, DOORS, FRAMES, AND WINDOWS TO MATCH EXISTING. 6 PATCH AND REPAIR ALL EXISTING CELLINGS

30. WHEN VALUE ENGINEERING ANY PROJECT OR PARTITIONS, AND FLOORS DISTURBED FOR NEW PART OF ANY PROJECT. THE CONTRACTOR SHALL WORK DOCUMENT FACH COMPONENT COST IN A SCHEDULE AND FINISH THAT IS PROVIDED TO THE OWNER FOR REVIEW. THE 7. ALL WALL FINISHES TO BE REMOVED SHALL BE

SCHEDULE SHALL SHOW THE COST OF CONSTRUCTION REMOVED TO FACE OF STUD. PRIOR TO AND AFTER VALUE ENGINEERING AND SHALL 8. THE CONTRACTOR SHALL PROTECT ALL INCLUDE ADDITIONS AND REDUCTIONS OF BOTH INTERIOR SPACES FROM DAMAGE DUE TO WEATHER. THE CONTRACTOR SHALL BE RESPONSIBLE FOR MANUFACTURING AND INSTALLATION. REPLACING/REPAIRING ANY DAMAGE DUE TO

31. THE VALUE ENGINEERING SCHEDULE SHALL WEATHER. COORDINATE WITH OWNER RELOCATION OF ANY FURNISHINGS DURING CONSTRUCTION. 32. ADJACENT PROPERTIES, STREETS AND WALKS ARE 10. THE CONTRACTOR IS TO MAINTAIN A SEPARATION BETWEEN AREAS WITHIN THE SCOPE OF ALL EXPOSED SIDES TO BE FINISHED TO MATCH WORK AND AREAS OUTSIDE OF THE SCOPE OF WORK BY PROVIDING PLASTIC SHEATHING BETWEEN

10. ELECTRICAL DEVICES ARE SHOWN FOR CONTIGUIOUS SPACES AND/OR TEMPORABILY TABING COORDINATION PURPOSES ONLY. REF. ELECTRICAL.

GENERAL DESCRIPTION OF WORK CONTIGUOUS SPACES AND/OR TEMPORARILY TAPING OF JOINTS AND GAPS TO PREVENT DUST MIGRATION. 11. DISPOSE OF ALL DEMOLISHED OR REMOVED

12. DISPOSE OF ALL DEMOLISHED OR REMOVED

13519

RECEPTACLES SHOWN IN MILLWORK SHALL HAVE

REMODEL OF EXISTING SINGLE FAMILY RESIDENCE LOCATED IN THE PROPERTY @ 13519

GENERAL NOTE

> LOCAL HAULING & DISPOSAL REQUIREMENTS. 12. IT IS THE CONTRACTORS RESPONSIBILITY TO LOCATE AND REMOVE ANY MECHANICAL, ELECTRICAL, AND PLUMBING EQUIPMENT NECESSARY TO TO MECHANICAL, ELECTRICAL, PLUMBING, AND STRUCTURAL DRAWINGS FOR DEMOLITION

MATERIAL LEGALLY FROM THE SITE. COMPLY WITH ALL

13. THE OWNER HAS FIRST RITE OF REFUSAL FOR ALL SALVAGED ITEMS. ITEMS NOT CLAIMED BY THE 2015 IEEC PRESCRIPTIVE ALL SALVAGED ITEMS. ITEMS NOT CLAIMED BY THE OWNER BECOME THE RESPONSIBILITY OF THE CONTRACTOR, AND SHALL BE DISPOSED OF FROM THE

THE ARCHITECT HAS NO KNOWLEDGE OF AND TO BE LOCATED IN ATTIC. SHALL NOT BE HELD LIABLE FOR ANY ASBESTOS OR OTHER HAZARDOUS MATERIALS ON-SITE. THE 3. CONTRACTOR SHALL IMMEDIATELY ISOLATE THE PRESSURE & AIR FLOW AFFECTED AREA IF ASBESTOS OR OTHER HAZARDOUS 4. AIR FILTER HOUSING MUST BE AIRTIGHT MATERIALS ARE DISCOVERED DURING CONSTRUCTION, ABOVE THE GARAGE AND NOTIFY THE OWNER AND ARCHITECT.

ASBESTOS CONTAMINATED PRODUCTS. MATERIALS SEALED THOUGHT TO CONTAIN ASBESTOS MUST BE INSPECTED BY AN EPA CERTIFIED INSPECTOR CAPABLE OF SPACE SAMPLING FOR THE EXISTENCE OF ASBESTOS. WORK ADJACENT TO GARAGI SHALL BE DONE IN ACCORDANCE WITH THE MOST 8. PENETRATIONS MUST SEALED CURRENT OSHA REGULATIONS & DISPOSED OF IN 9. DOORS MUST HAVE WEATHER STRIPPING ACCORDANCE WITH CURRENT EPA REGULATIONS. EXISTING CONSTRUCTION MAY CONTAIN LEAD

EXISTING CONSTRUCTION MAY CONTAIN LEAD

ELECTRICAL NOTES

ELECTRICAL NOTES CONTAMINATED PRODUCTS, MATERIALS THOUGHT TO CONTAIN LEAD MUST BE INSPECTED BY AN EPA CERTIFIED INSPECTOR CAPABLE OF SAMPLING FOR

REGULATIONS & DISPOSED OF IN ACCORDANCE WITH $\frac{2}{3}$ CURRENT EPA REGULATIONS.

REQUIREMENTS OF THE LAW. IT IS INCUMBENT ON 1 PLAN DIMENSIONS ARE TO CENTER LINE OF ANYONE PERFORMING RESIDENTIAL CONSTRUCTION STUD OR EXTERIOR FACE OF BRICK/FOUNDATION. 2. DIMENSIONS TO ROUGH PLUMBING LOCATIONS ABOVE FINISH WALKING SURFACE TO CENTERLINE OF ASPECTS OF THE CURRENT BUILDING CODE TO ASSURE

ARE TO CENTERLINES OF WALL AND ARE INDICATED AS

BRACKET, U.N.O. THAT STRUCTURES THEY ARE BUILDING MEET THE

A GUIDE TO ROUGH-IN PLUMBING. QUANTITY AND

8. SMOKE DETECTORS: 110 VOLT. COORDINATE W/ T: XXX.XXX.XXXXX SIZE OF PLUMBING STACKS ARE NOT DETERMINED BY ALARM SYSTEM. DETECTORS TO COMPLY WITH 18. KEEP DIRT TO A MINIMUM - WALK OFF MATS CONNENT BOILDING CODE.

SIZE OF PLUMBING STACKS ARE NOT DETERMINED BY ASSESSMENT BOILDING CODES AND REGULATIONS.

SIZE OF PLUMBING STACKS ARE NOT DETERMINED BY ASSESSMENT BOILDING CODES AND REGULATIONS.

SHALL BE PROVIDED AT ENTRANCES - MATS SHALL BE 2. ALL FRAMING SHALL CONFORM TO ALL FOUNDATION PLUMBING LAYOUT. ROUGH-IN FOR GOVERNING CODES AND REGULATIONS. APPLICABLE SECTIONS OF THE INTERNATIONAL FIXTURES, SHOWERS, AND OTHER REQUIRED SLAB 9. PROVIDE 220V JUNCTION BOX AND OTHER LEAVE OUTS SHOULD BE VERIFIED BY THE PLUMBER REQUIRED WIRING FOR HVAC UNITS. VERIFY

EXCEEDING 10 FEET REQUIRE STRUCTURAL ANALYSIS 15. VERIFY ALL HANGING FIXTURE HEIGHTS W/

8. FIELD VERIFY LOCATION OF ALL EXISTING WALLS 19. ALL APPLIANCES, PLUMBING AND LIGHTING 6. WOOD CROSS BRIDGING, BLOCKING, AND AS LOCATIONS MAY DIFFER FROM THOSE SHOWN ON FIXTURES NOT SPECIFIED IN THE DRAWINGS SHALL BE

VERIFY WOOD SPECIES WITH ARCHITECT IN ALL SHALL MATCH STAINED WOOD TRIM TYPICAL, U.N.O.

12. CONTRACTOR SHALL PROVIDE BLOCKING AS OTHER PERSONS OR ENTITIES PERFORMING WORK ON 9. JOIST HANGERS SHALL BE 16 GA., TYPE "U" AS REQUIRED FOR ALL MILLWORK AND EQUIPMENT INSTALLATION. 2X6 STUDS UNLESS NOTED OTHERWISE.

TAPED AND FINISHED

INSTALLATION INSTRUCTIONS TO DETERMINE ROUGH OPENING OF POCKET DOOR, COORDINATE W/ ARCH. MANUFACTURERS SHALL APPLY AND BE ADHERED TO. 10. PLYWOOD SUBFLOORING SHALL BE APA RATED 15. CEILING HEIGHT NOTED FOR EACH ROOM IS TO

> 2 CONTINUOUS FULLY-ADHERED ROOFING ALL OTHER SHEATHING TO BE NAILED AT 6" O.C. AT MEMBRANE TO BE APPLIED SHINGLE STYLE OVER EDGES AND A 12" O.C. IN THE CENTER OF THE ENTIRE ROOF INCLUDING OVERHANGS AT EAVES AND SHEATHING PANELS. SHEATHING AT GABLE RAKES RAKES AND OVER PORCHES AND BREEZEWAY. SHALL BE NAILED AT 4" O.C. AT OUTLOOK BLOCK & AT CONTINUOUS FULLY-ADHERED ROOFING MEMBRANE TO BE EXTENDED MIN. 12" UP/ DOWN EXTERIOR WALL SHEATHING AT ALL ROOF-WALL INTERSECTIONS

12. ALL BORED HOLES SHALL BE 2" CLEAR FROM THE EXCEPT WHERE PORCH OR BREEZEWAY ROOF MEETS

GALVANIZED STRAPS, 18" LONG, BOTH SIDES OF WALL OVER ROOF MEMBRANE AND 12" UP FACE OF WALL INSULATION SHEATHING

ALL SIDING SHALL BE OF SMOOTH TYPE UNLESS NOTED OTHERWISE. SEALANT AT EXPANSION JOINTS SHALL MATCH

WINDOWS ORDERED, AND CURRENT MANUFACTURERS

8. ALL NECESSARY ROOF PENETRATIONS &

SCRIBE ALL CABINETRY TO THE WALL & FLOORS. CONTRACTOR SHALL PROVIDE SHOP DRAWINGS FOR OWNER AND DESIGNER APPROVAL. INSTALL ELECTRICAL PLUGS UNDER ALL UPPER CABINETRY IN KITCHEN AND BUTIER'S PANTRY, U.N.O. A THIN VALENCE TO BE ADDED TO BOTTOM OF JPPERS WHERE OUTLETS AND/OR UNDER CABINET

LIGHTING IS SPECIFIED. ALL CARINETS SHALL HAVE A 1/8" REVEAL NO SCREEN MOLD.

FIELD VERIFY ALL MEASUREMENTS BEFORE PROVIDE REO'D BLOCKING FOR ALL WAL CABINET INSTALLATION PROVIDE ADDITIONAL SUPPORT AT ALL WORK SURFACES AS REQUIRED, SUPPORTS ARE TO BE

DISCREET AND SHOULD BE CONCEALED IF POSSIBLE.

ADJACENT. CONTACT ARCHITECT IF CONFLICT OCCURS. TO INSIDE FACE OF CABINET. 11. ALL MILLWORK SUBSTRATES AT WET

13. OUTLETS PROVIDED NEAR SINKS, LAVS, ETC. ARE

TO BE GFRC TYPE - REF ELECTRICAL. MECHANICAL/INDOOR **AIR QUALITY NOTES**

AS REQUIRED, COLOR MATCH CAULK, UNO.

HVAC SYSTEM & GAS TANKLESS WATER HEATER AIR FILTERS MUST BE MERV 8 OR GREATER AIR HANDLERS MUST BE SIZED TO MAINTAIN AIR

PENETRATIONS MUST BE SEALED 15. EXISTING CONSTRUCTION MAY CONTAIN 6. FLOOR AND CEILING JOISTS BAYS MUST BE PAINTED WALLS & CEILINGS OF CONDITIONED

ELECTRICAL INSTALLATION SHALL MEET

VERIFY UTILITIES AND LOCATIONS WITH

CONTRACTOR

REQUIREMENTS OF APPROVED CITY CODES AND THE EXISTENCE OF LEAD. WORK SHALL BE DONE IN REGULATIONS ACCORDANCE WITH THE MOST CURRENT OSHA

17. THE GENERAL CONTRACTOR SHALL REMOVE ALL UNUSED SWITCH PLATES, WIRING, AND EQUIPMENT. ALL WIRES AND CONDUIT NOT COMPLETELY REMOVED TO THE SOURCE MUST TERMINATE IN A JUNCTION BOX WITH COVER AND APPROPRIATE INSULATORS

FLOOR TO CENTERLINE OF OUTLET UNLESS NOTED

SUFFICIENT TO MAINTAIN COMPLIANCE WITH 1. UTILIZATION OF FOLLOWING CHECKLIST DOES FLOOR PLAN NOTES

CONTRACTOR TO BE SURE CURRENT MANUFACTURING PROTECTED.

FINISHED FACE OF CEILING.

1. PROTECT EXISTING ROOFS FOR DURATION OF



ROUGH-INS EXTENDED SO COVER PLATE WILL MOUNT LAMBERT LANE IN THE CITY OF KELLER, TX 76262 (COLEMAN ADDITION BLOCK A, LOT 1). 12. CAULK AT ALL COUNTERS AND BACKSPLASHES SCOPE OF WORK: SINGLE FAMILY, 2-STORY CUSTOM HOME OF APPROXIMATELY 10,730 SQ.FT. ROOM TAG

> THE RESIDENCE HAS 6 BEDROOMS, 7 BATHROOMS, 1 HALF-BATHROOM, ONE 3-CAR GARAGE. & ONE 1-CAR GARAGE. THE LOT IS 5.1 ACRES.

THIRD PARTY GREEN & ENERGY CERTIFICATES TO BE PROVIDED BY G.C. AS REQUESTED BY THE CITY.

SCOPE OF WORK CALCULATIONS

NEW A.C. SQ.FT. 6,949 SQ.FT NEW GARAGE SQ.FT 993 SQ.FT NEW PORCH SQ.FT. 2,788 SQ.FT TOTAL STRUCTURE SQ.FT. 10,730 SQ.FT.

FIRE SPRINKLER NEEDED: YES

UNDER ROOF W/ 6,949 SQ.FT. BEING LIVABLE AIR CONDITIONED SPACE.

PROJECT TEAM ARCHITECTURE & INTERIOR DESIGN

MANOLO DESIGN STUDIO SWITCHED CONVENIENCE OUTLETS TO BE 4925 GREENVILLE AVE., STE. 350 SWITCHED AT TOP OUTLET ONLY. SWITCHES: 4'-0" ABOVE FINISH FLOOR TO DALLAS, TX 75206 CENTERLINE OF SWITCH, UNLESS NOTED OTHERWISE

T: 214.501.4984

STRUCTURAL ENGINEER

DRAWING ABBREVIATIONS

air conditioned

adjustable

aluminum

bottom of

between

board

building

cabinet

ceiling

closet

column

concrete

continuous

coordinate

cold water

down spout

corridor

deep

double

diameter

dimension

control joints

center line

centimeter

BLDG

CJ

CLG

CLO

CM

COL

CONC

CONT

CORR

DBL

DIA

DN

COORD

architectural

A.F.F. above finished floor DW dishwasher

DWG drawing

DWR drawer

ELEC electric

EQ equal

FN

FT

GFO

GYP

GWB

HOR

INSUL

GL

ELEV elevation

EQUIP equipment

ESMT estimated

floor

finish

freezer

feet

glss

high

gypsum

hose bib

handicapped

horizontal

hot water

insulation

interior

height

inch

F.F.E finishes, fixtures & equipment

general contractor

gypsum wallboard

ground fault interpreter

heating ventilation + air conditioning

XXXXX XXXXX XXXXX

OTHERWISE 6. INTERIOR WALL BRACKET FIXTURES: 66" ABOVE FINISH FLOOR TO CENTERLINE OF BRACKET UNLESS NOTED OTHERWISE.

FXTERIOR WALL BRACKET FIXTURES: 6'-10"

CONTRACTOR LOCATIONS WITH CONTRACTOR.

ALAIR HOMES 305 WEST SPRING CREEK PARKWAY, UNIT 104C WATER PROOF AND ON A GROUND FAULT CIRCUIT. DOCUMENTS AND BUILDING OFFICIAL DIRECTIONS.

WOOD CONNECTIONS SHALL BE IN ACCORDANCE

4. WINDOWS SPECIFIED NEED TO BE CHECKED BY

12. ALL RECEPTACLES IN ALL BEDROOMS TO BE AFCI

PLANO, TX 75023 T: 469.682.0210

EXPECTED TO BE FINALLY REVISED BY OWNER/

A/C POCKET DOORS, AND WALLS BEHIND WATER CLOSETS 17. ELECTRICAL INSTALLER SHALL LOCATE ROUGH IN ADJ. BOXES AS INDICATED ON PLANS, WALK THE PROJECT FINAL APPROVAL LOCATIONS TO COMPLY WITH LOCAL CODE REQUIREMENTS. BD

DRAWING SYMBOLS

ENLARGED CALLOUT

CEILING TAG

FINISH TAG

WALL TYPE TAG

NORTH ARROW

DRAWING SCALE

BUILDING SECTION

DETAIL SECTION

REVISION CLOUD

RCP

REF

REQ

REV

EΜ

SD

SP

SPR

SQ

SS

STL

STO

T.O.

TEL

TV

TYP

U.C.

U.M.

U.N.O.

SQ.FT.

SCHED

SHLVS shelves

required

revisions

schedule

similar

speaker

sprinkler

square

stone

steel

stone

tile

top of

telephone

television

under counter

unless otherwise noted

under mount

typical

STRUCT structure

standing

specification

solid surface

square footage

smoke detector

room

iunction box

manufacturer

maximum

minimum

millimeter

microwave

not in contract

not applicable

provided by owner

not to scale

overhead

opposite

plate

plastic

plywood

powder

quantity

radius

mirror

metal

north

mechanical

miscellaneous

long

laminate

lavatory

meter

MANUF


MTL

MW


N.T.S.


P.B.O.

PWDR

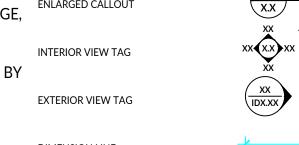



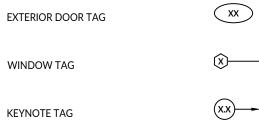

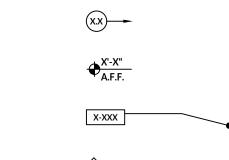



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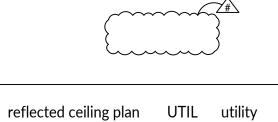
ROOM NAME

123

X'-X"



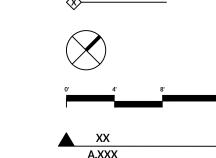

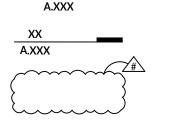

V.I.F. verify in field VEST vestibule W wide W.C. water closet W.H. water heater WD wood water proof WRM warming

WSCT wainscot vard

water resistant

VICINITY MAP

DRAWING SHEET INDEX

ARCHITECTURE

G1.1

A0.21

A1.2

A1.4

A1.5

A1.6

A1.8

A1.9

A1.11

A1.12

A1.14

A1.15

A2.1

A2.2

A3.1

A4.1

A4.2

A5.1

A5.2

A5.5

A5.6

A5.7

A6.1

E1.1

E1.2

E2.2

ID1.1

ID1.2

ID1.3

ID1.4

ID1.5

INTERIORS

SHEET NUMBER SHEET TITLE

TITLE SHEET

SITE PLAN

SLAB PLAN

ROOF PLAN

1ST FLOOR PLAN

2ND FLOOR PLAN

1ST FLOOR FINISH PLAN

2ND FLOOR FINISH PLAN

SECTION DETAILS

ENLARGED VIEWS

ENLARGED VIEWS

INTERIOR DETAILS

INTERIOR DETAILS

WINDOW & DOOR SCHEDULES

1ST FLOOR LIGHTING PLAN

2ND FLOOR LIGHTING PLAN

1ST FLOOR POWER PLAN

2ND FLOOR POWER PLAN

INTERIOR ELEVATIONS

INTERIOR ELEVATIONS

INTERIOR ELEVATIONS

INTERIOR ELEVATIONS

INTERIOR ELEVATIONS

INTERIOR ELEVATIONS

1ST FLOOR REFLECTED CEILING PLAN

2ND FLOOR REFLECTED CEILING PLAN

EXTERIOR ELEVATIONS & BUILDING SECTIONS

EXTERIOR ELEVATIONS & BUILDING SECTIONS

INTERIOR DETAILS: TYPICAL WALL DETAILS

INTERIOR DETAILS: TYPICAL DOOR DETAILS

INTERIOR DETAILS: TYPICAL ROOF DETAILS

INTERIOR DETAILS: TYPICAL WINDOW DETAILS

INTERIOR DETAILS: TYPICAL FOUNDATION DETAILS

1ST FLOOR WALL FINISH PLANS

2ND FLOOR WALL FINISH PLANS

RIGHT-OF-WAY PLAN

ENERGY CODE COMPLIANCE

EXISTING 1ST FLOOR PLAN

EXISTING 2ND FLOOR PLAN


1ST FLOOR DEMOLITION PLAN

2ND FLOOR DEMOLITION PLAN

1ST FLOOR PLAN - KEYNOTES & CONSTRUCTION NOTES

2ND FLOOR PLAN - KEYNOTES & CONSTRUCTION NOTES

EROSION CONTROL COMPLIANCE

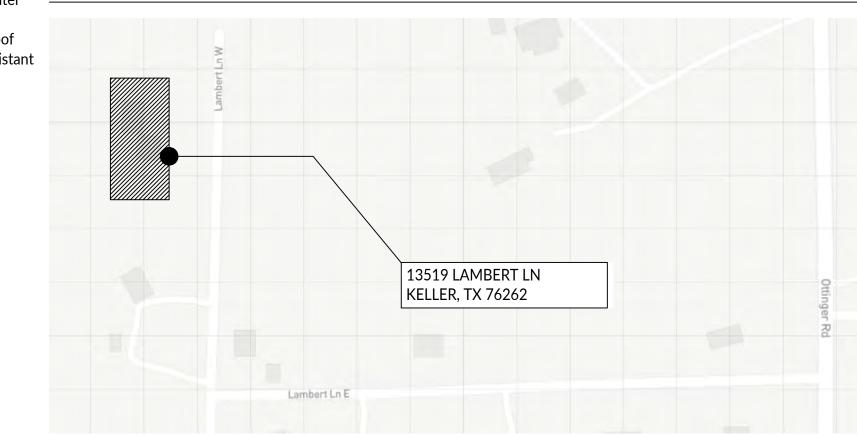

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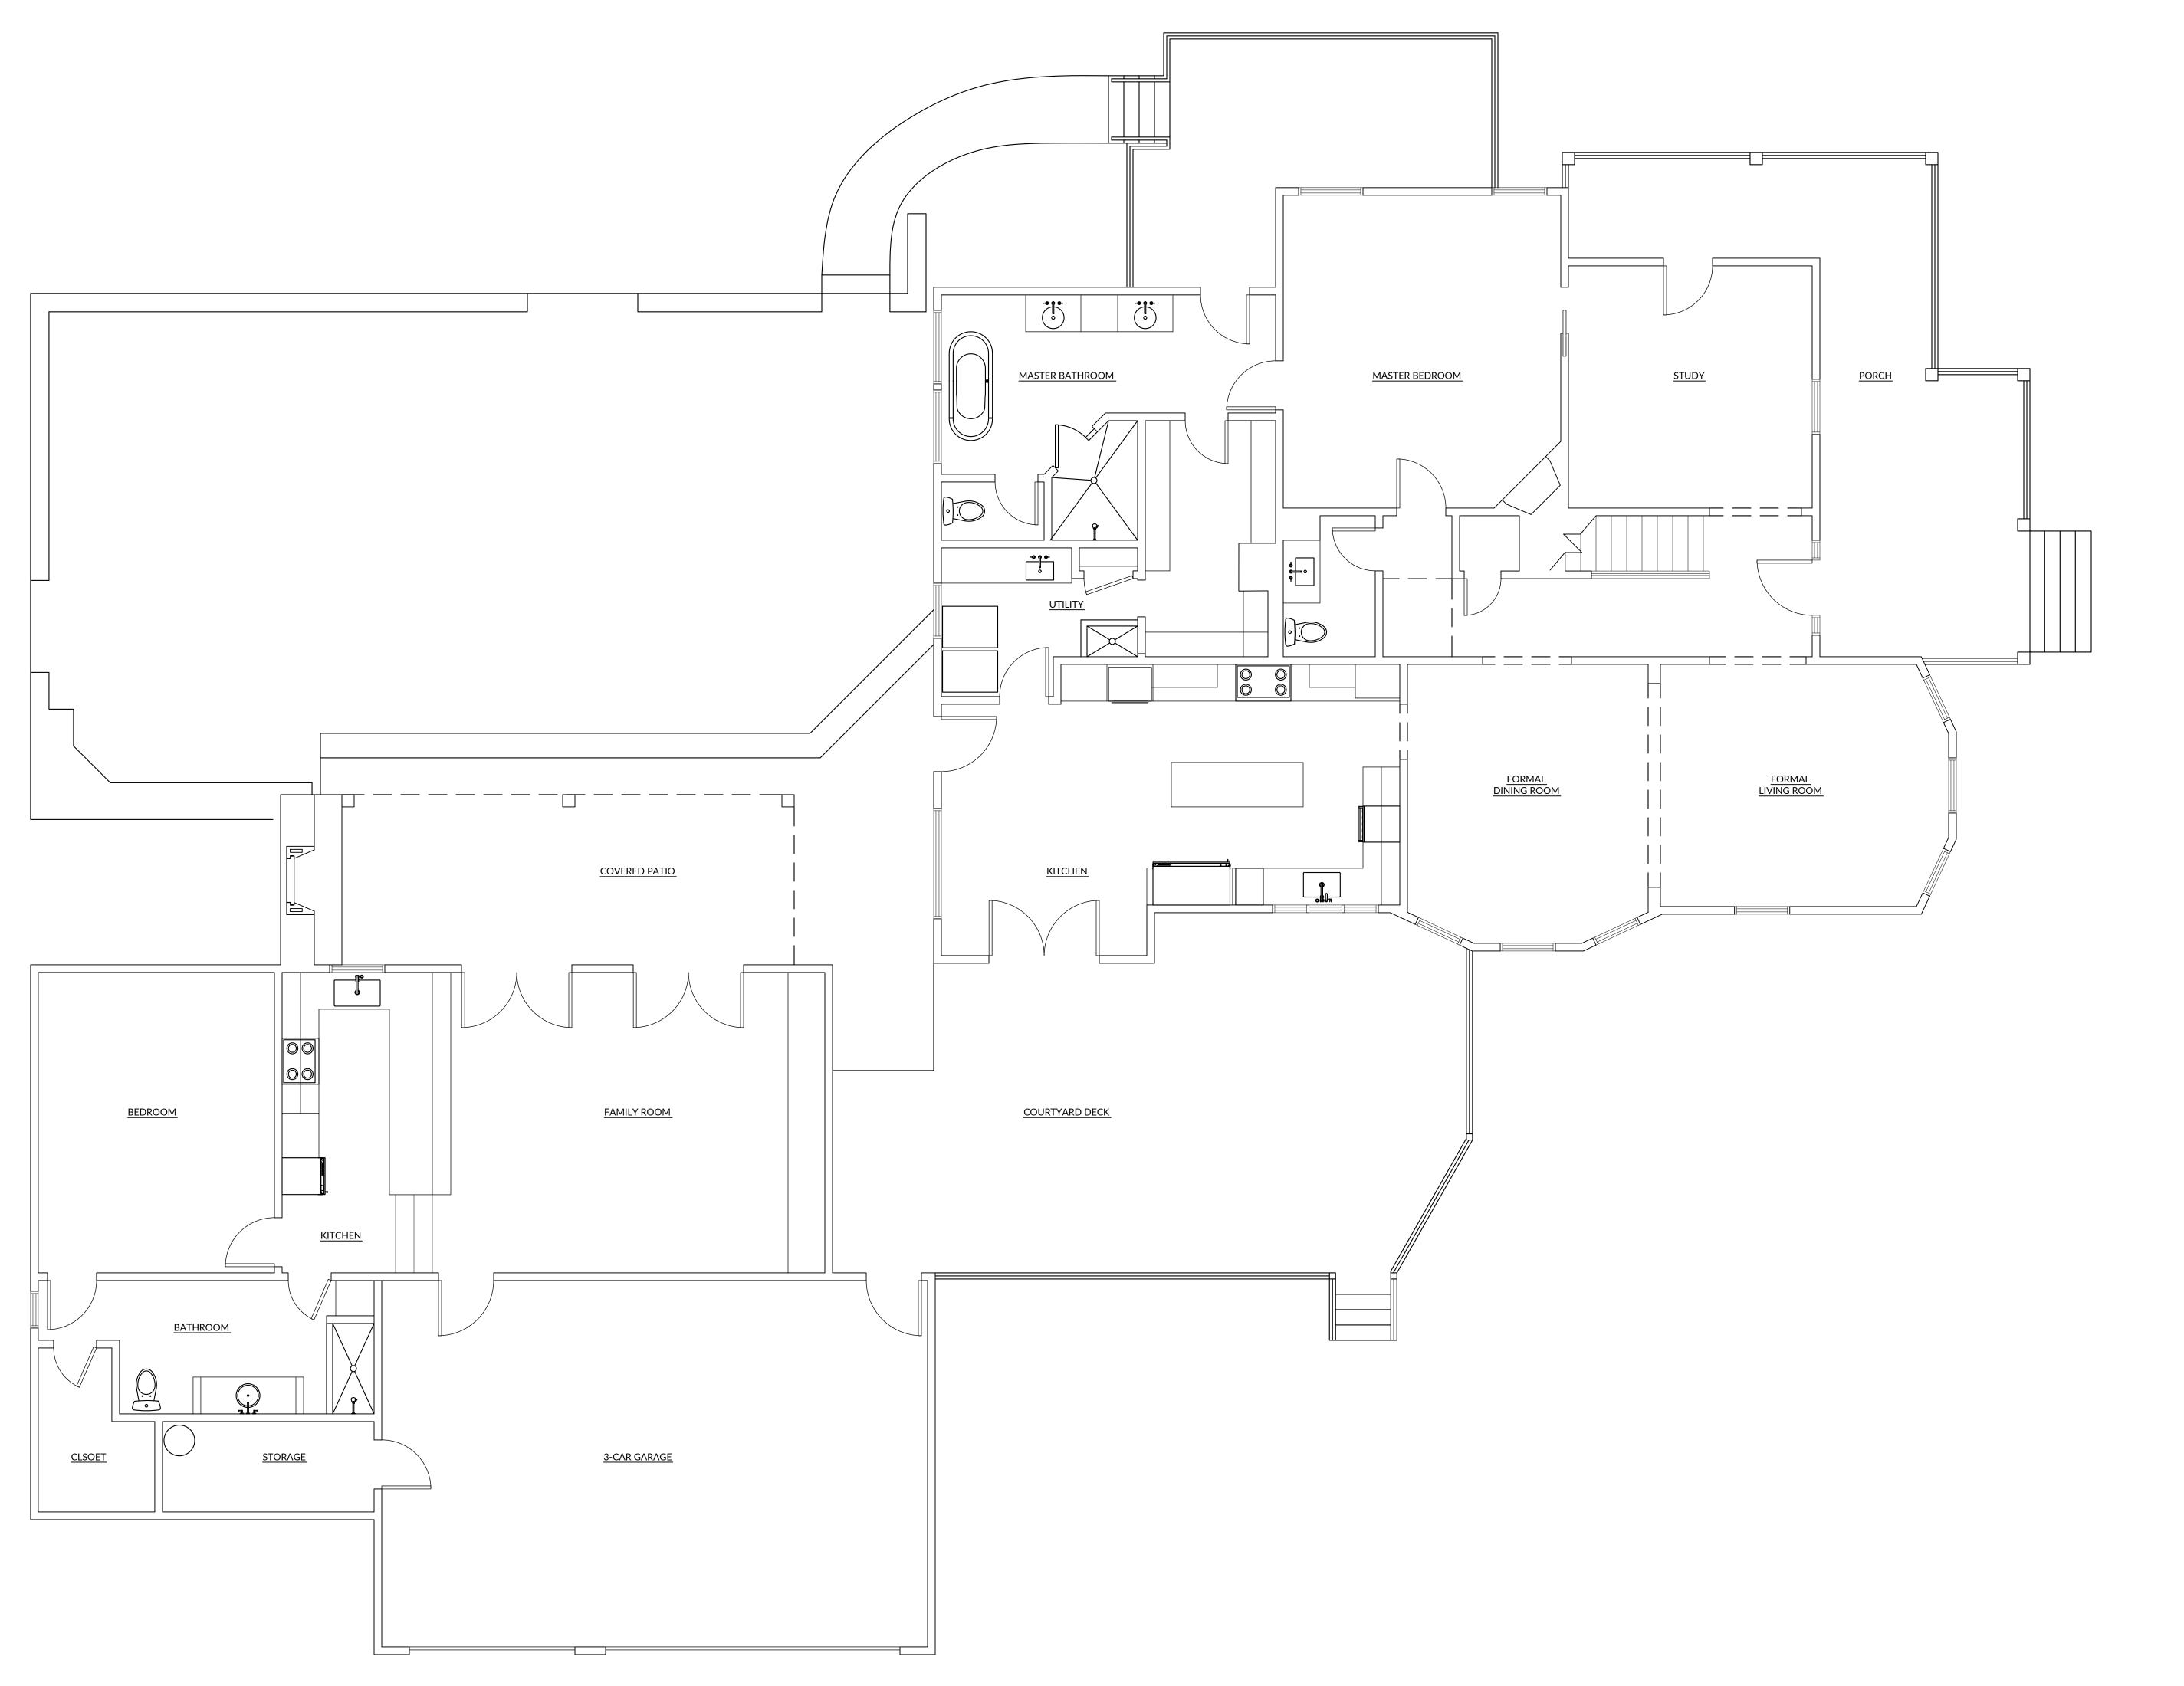
ARCHITECT: MANOLO BANDA ARCH. REG. NO.: 29491 Date: 5.1.2024

PROJECT NO: 24004 PROJECT ISSUE DATE

DRAWING TITLE:

TITLE SHEET

As indicated



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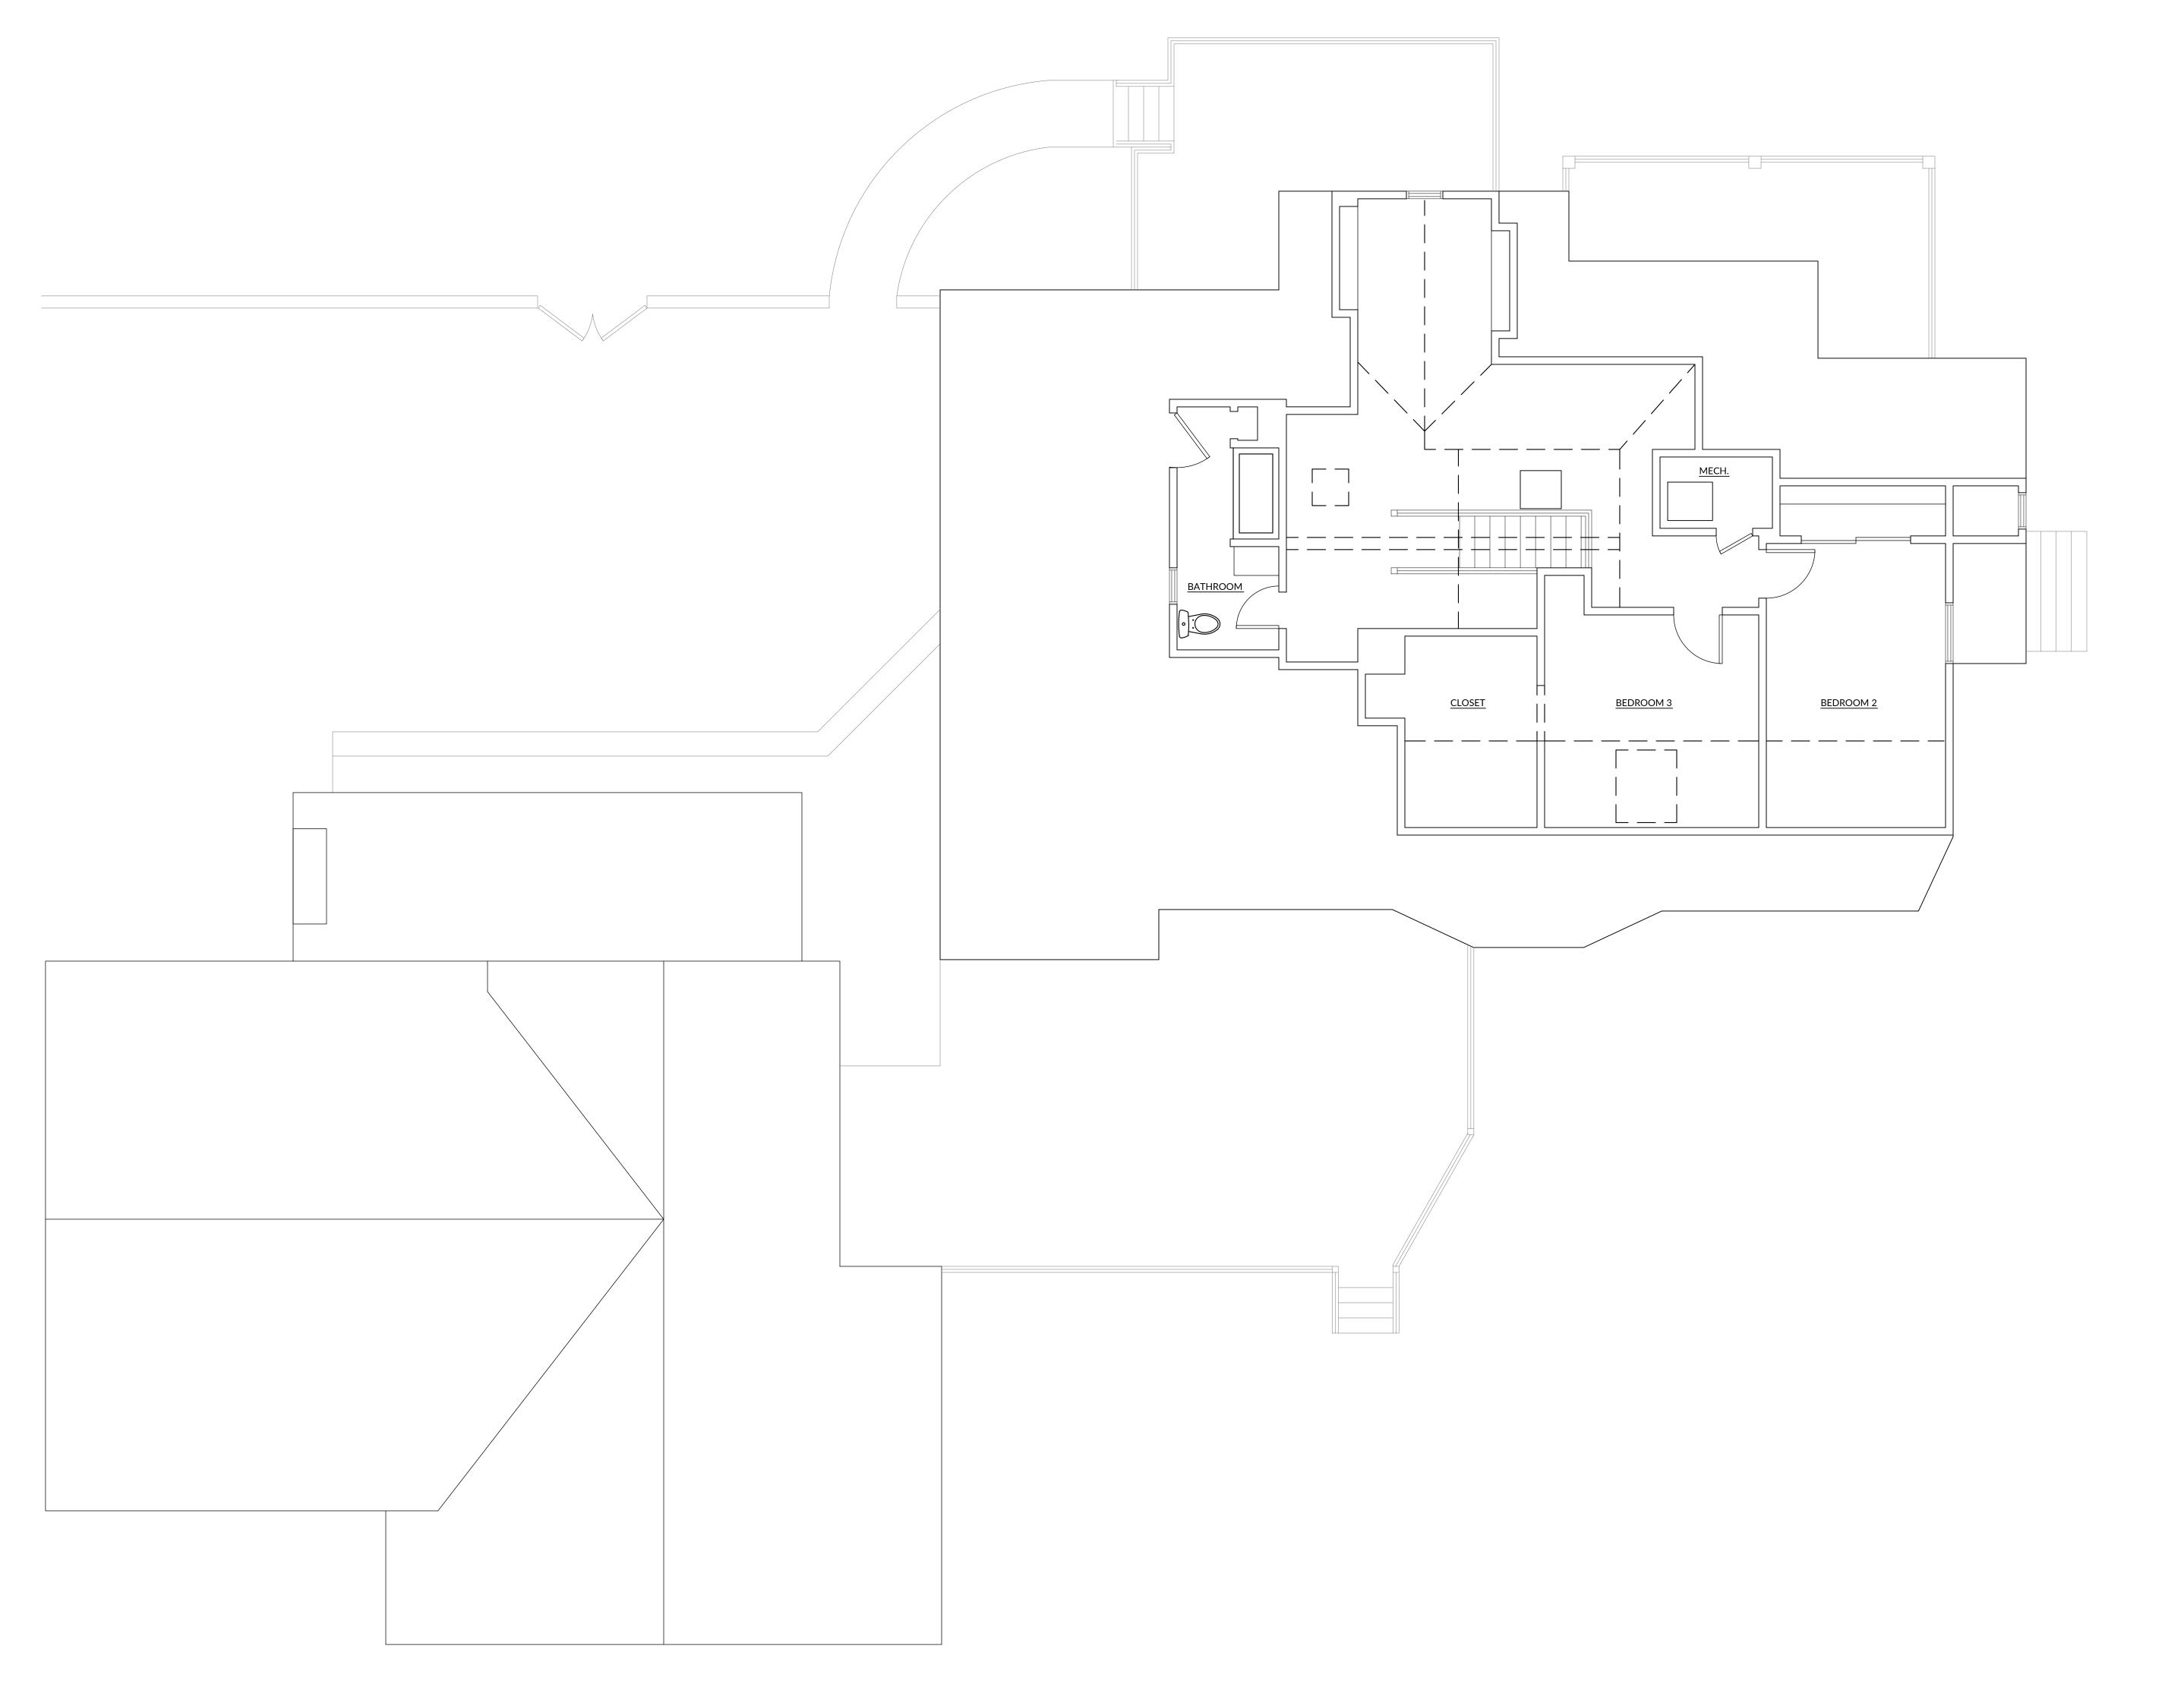
PROJECT NO: 24004 PROJECT ISSUE DATE: TBD

EXISTING 1ST FLOOR PLAN

As indicated

EXISTING FIRST FLOOR PLAN

SCALE: 0' - 1/4" = 1' - 0"



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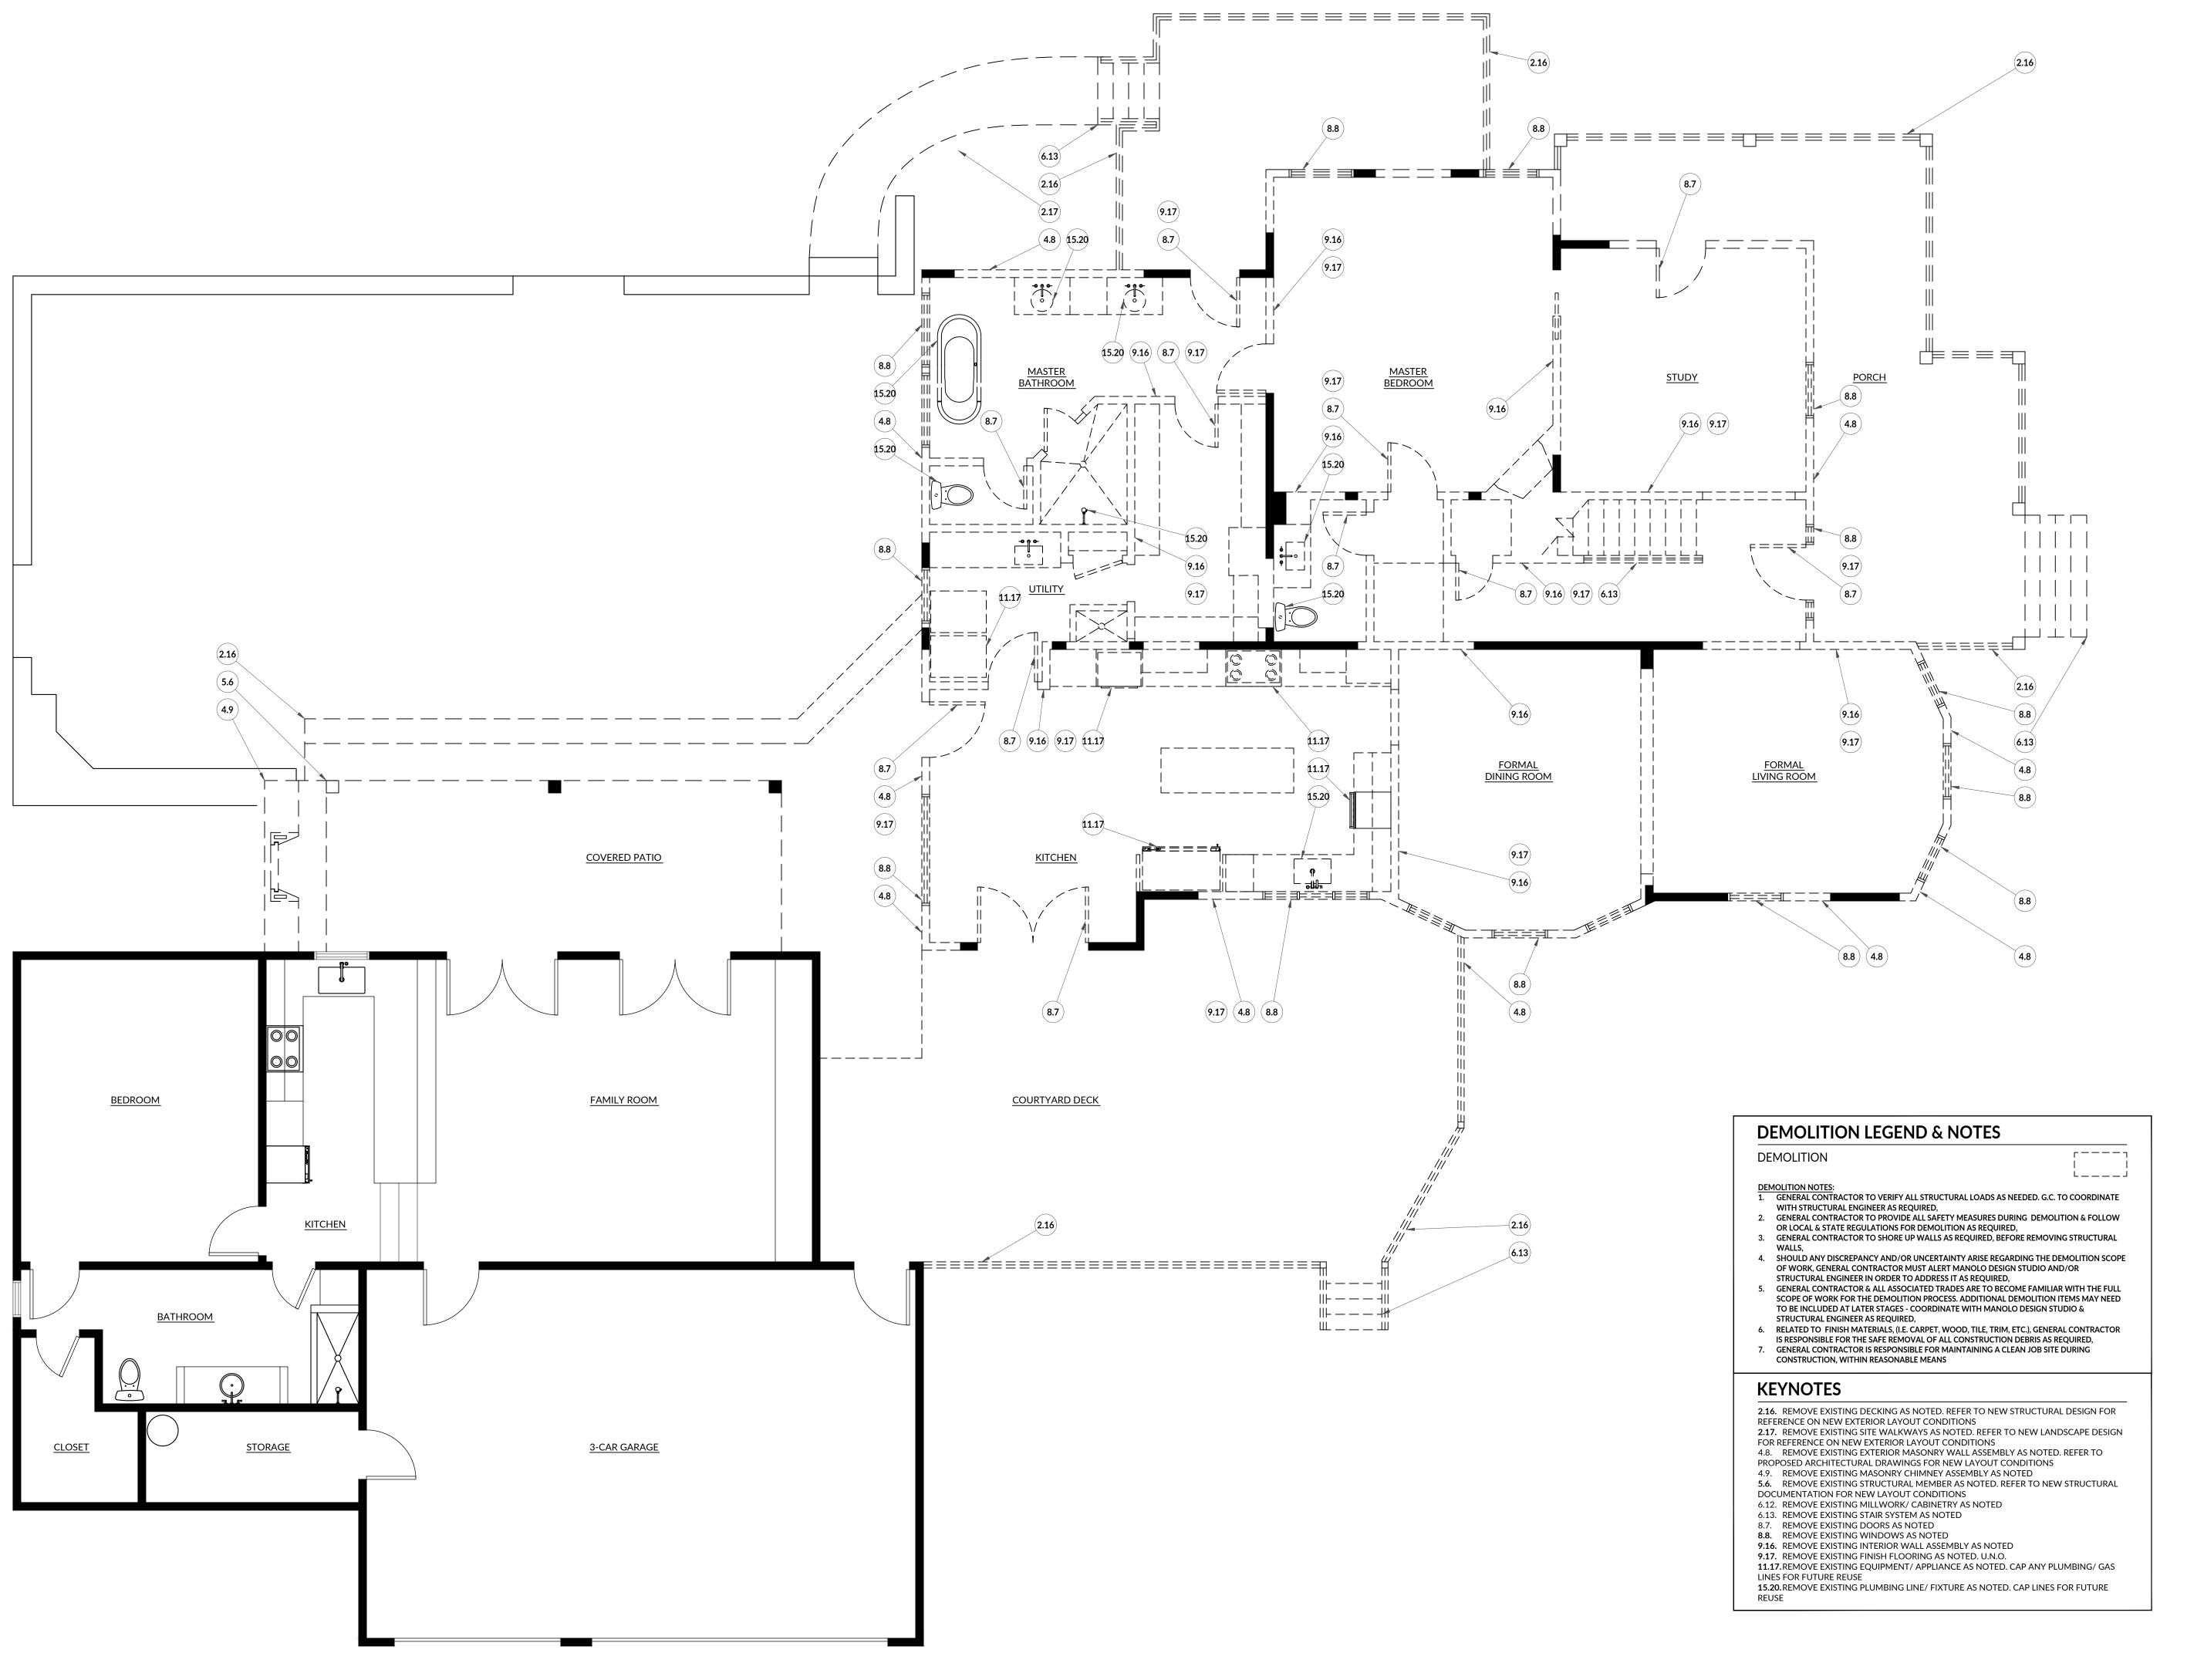
PROJECT NO:

PROJECT ISSUE DATE:

EXISTING 2ND FLOOR PLAN

24004

As indicated



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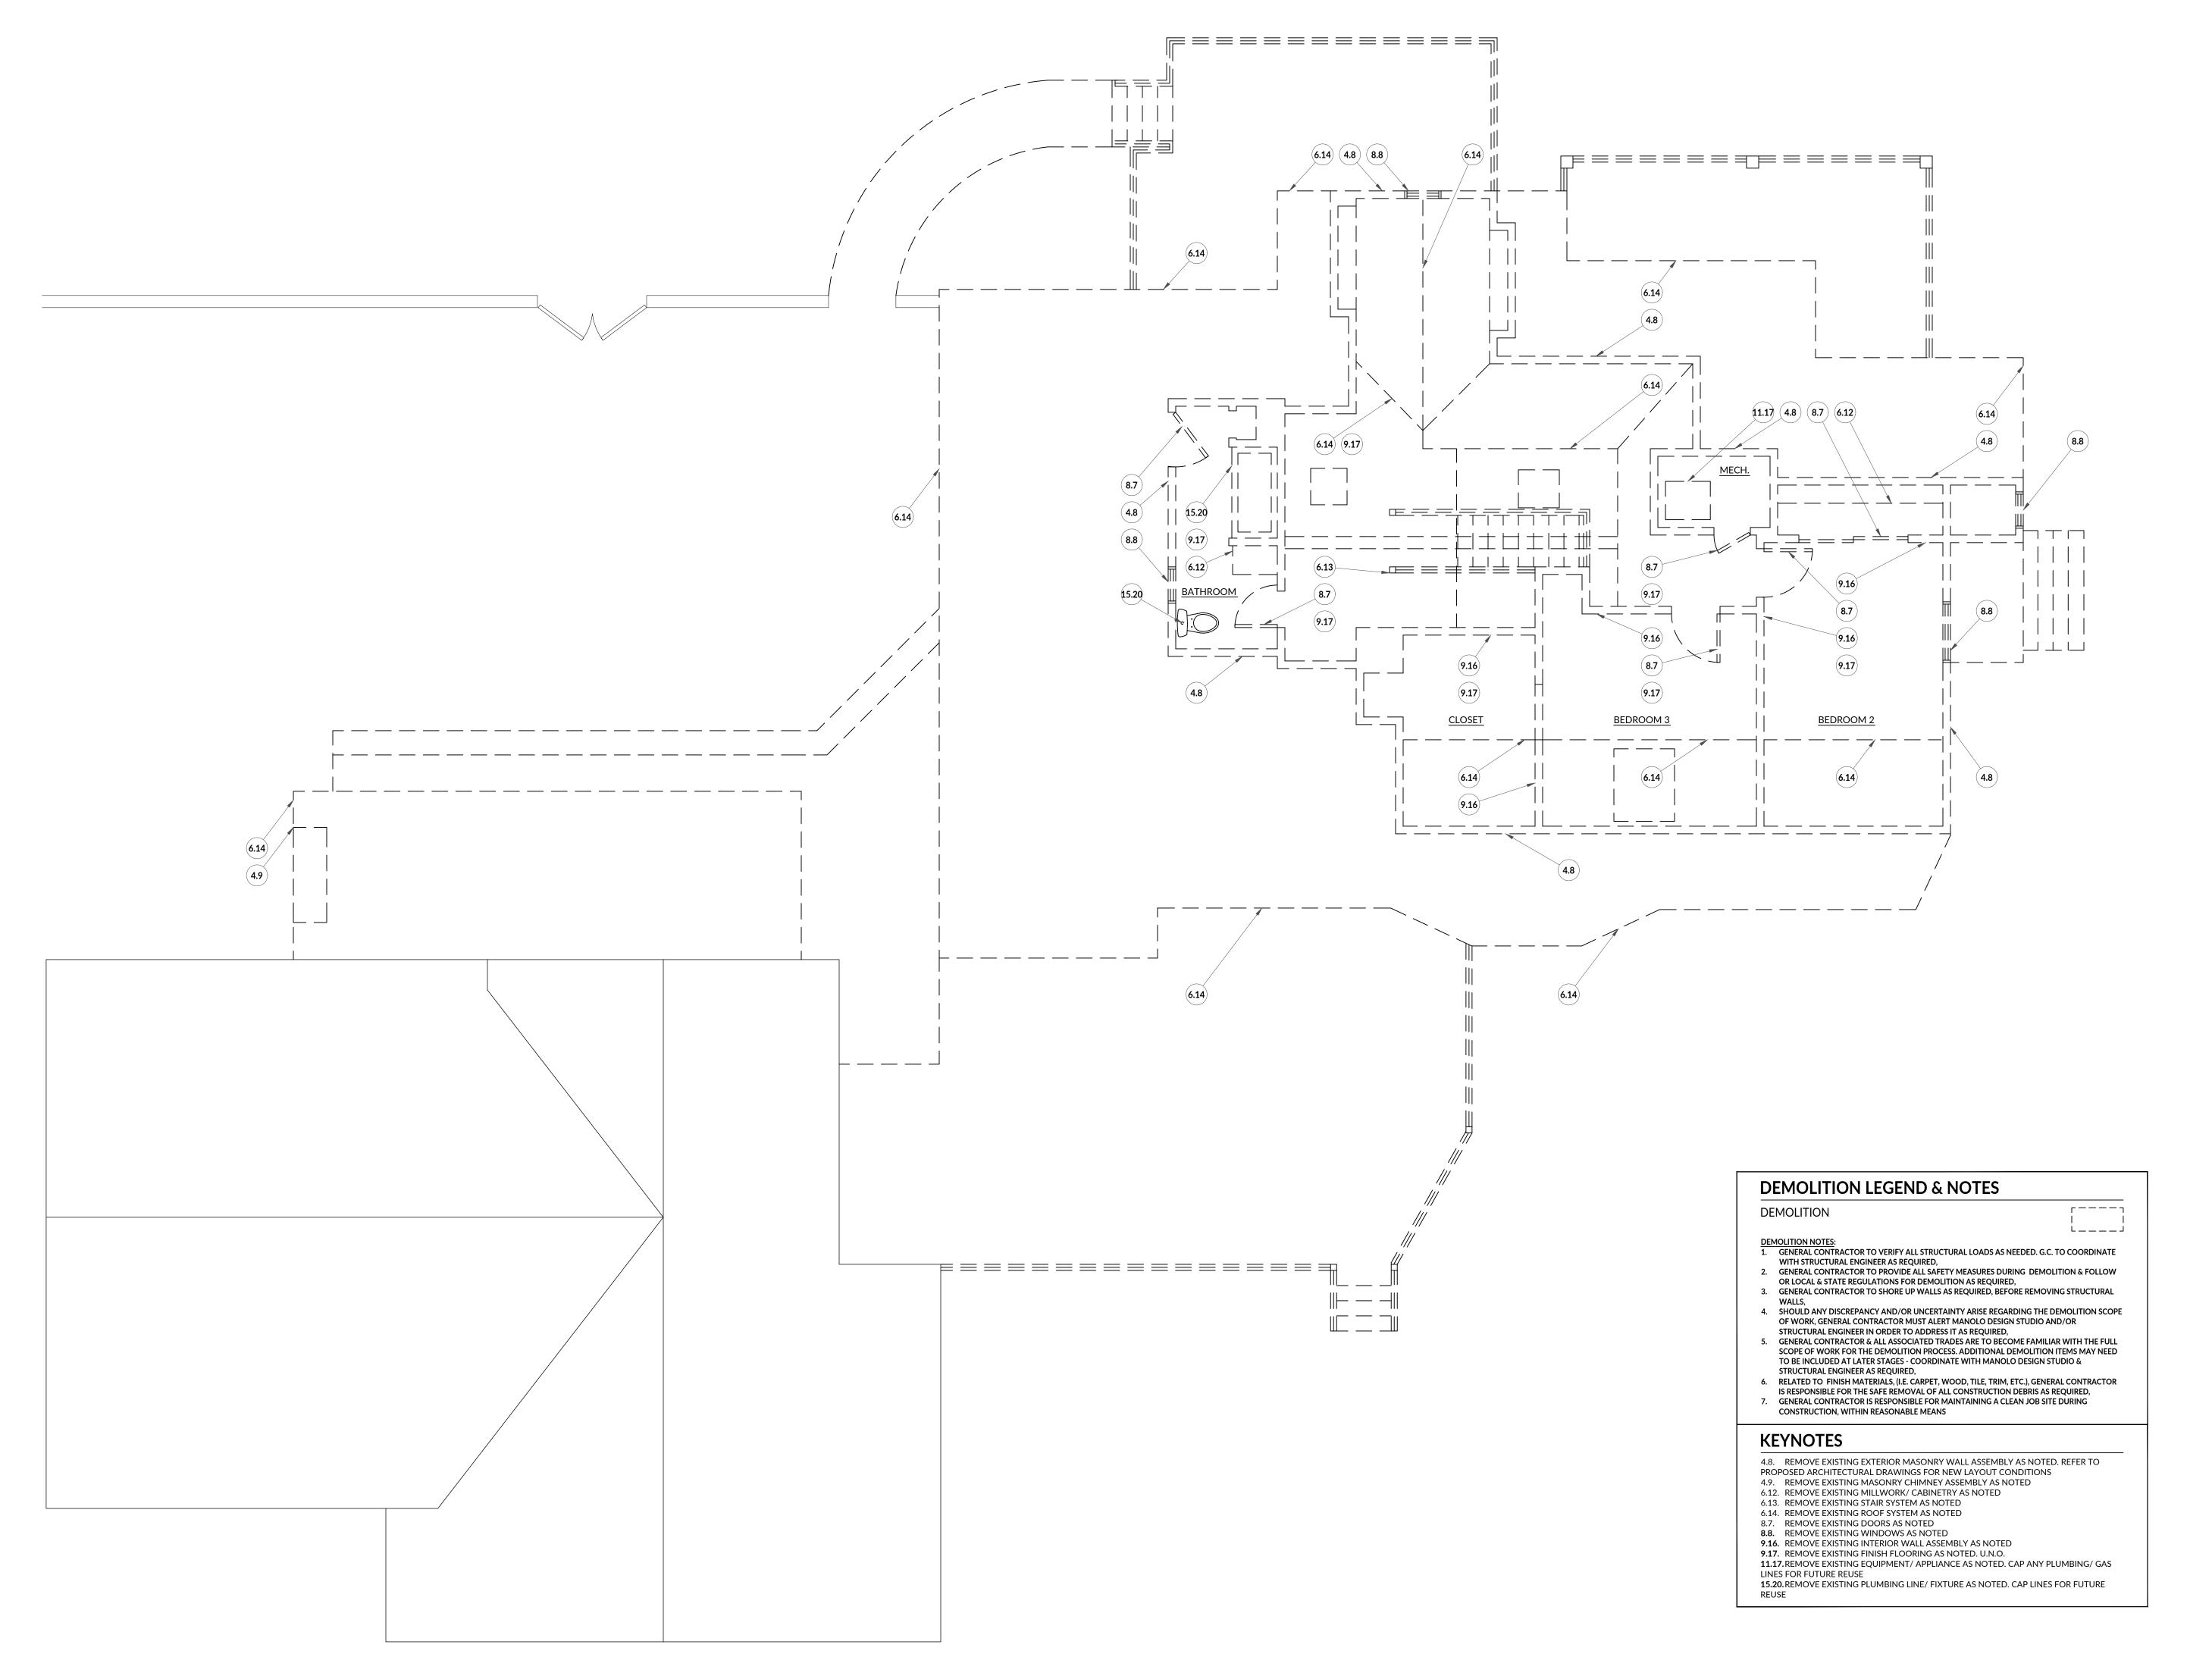
PROJECT NO: 24004

PROJECT ISSUE DATE:

DRAWING TITLE:

1ST FLOOR DEMOLITION PLAN

As indicated



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Date: 5.1.2024

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PROJECT NO: 24004

PROJECT ISSUE DATE:


DRAWING TITLE:

2ND FLOOR DEMOLITION PLAN

CALE:

As indicated

A0.22

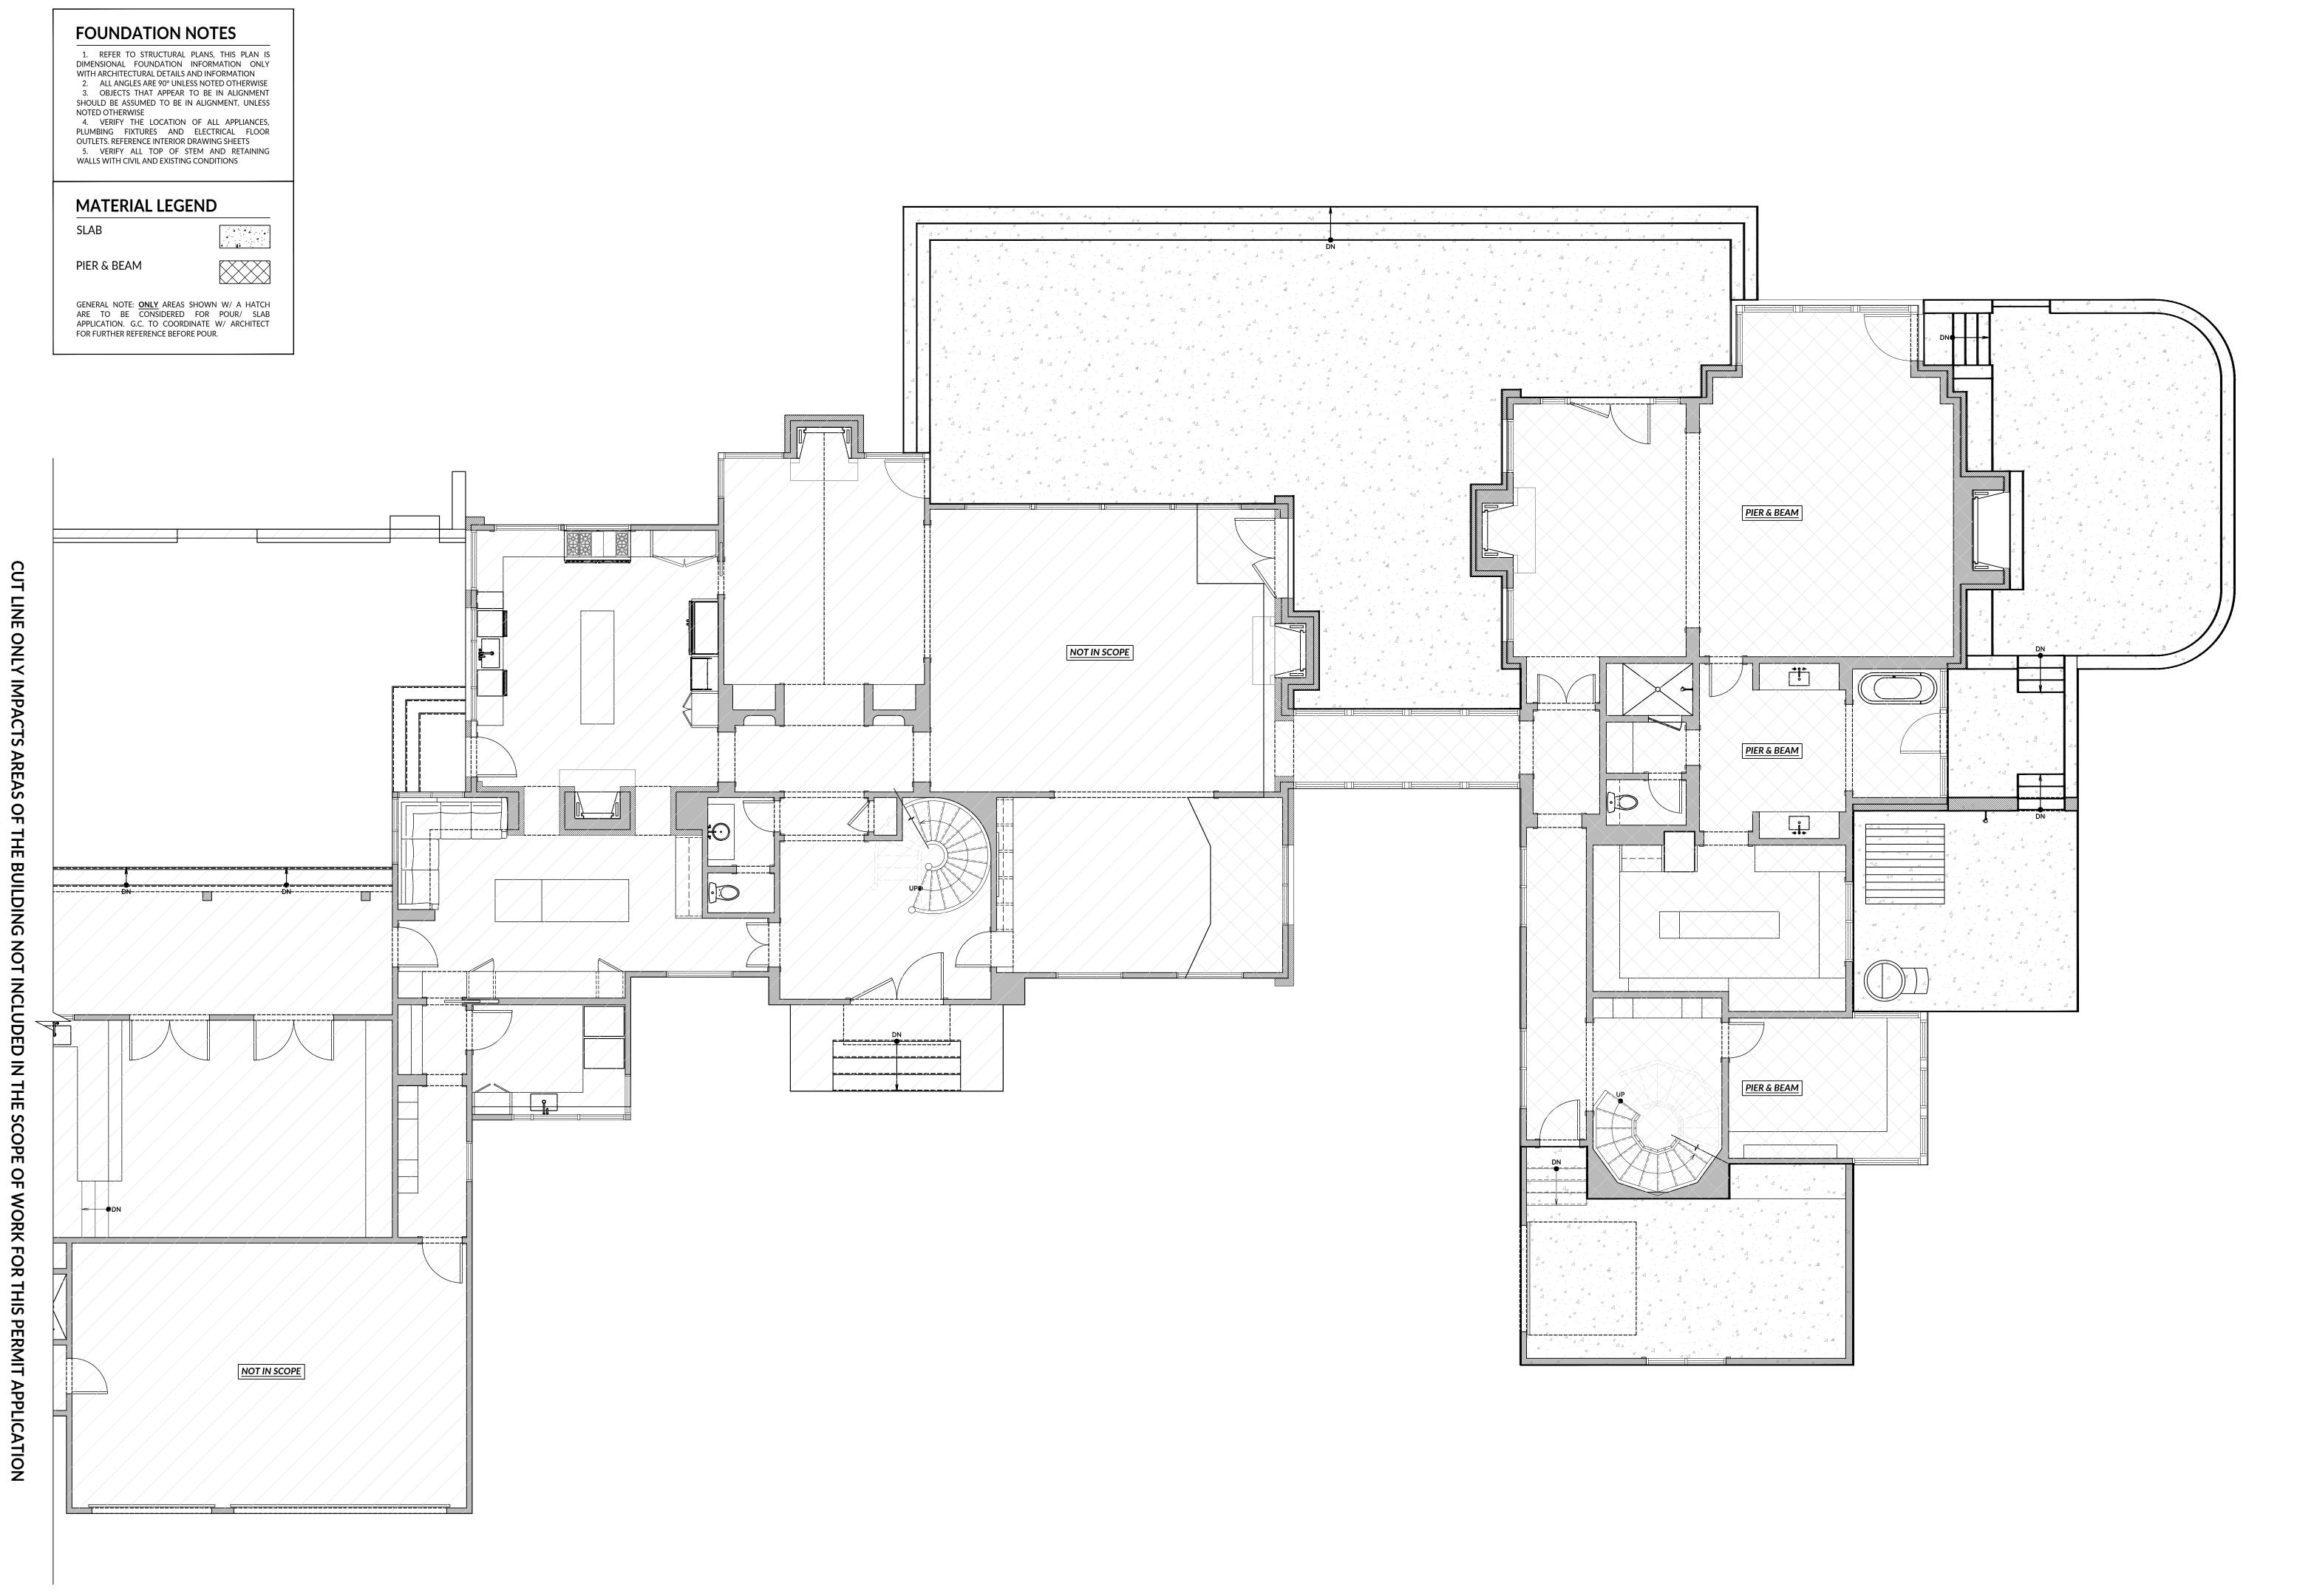

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Date: 5.1.2024

REVISIONS:

RAWN BY:

PROJECT ISSUE DATE:

DRAWING TITLE:

SLAB PLAN


24004

TBD

CALE:
As indicated

As ind

A1.0

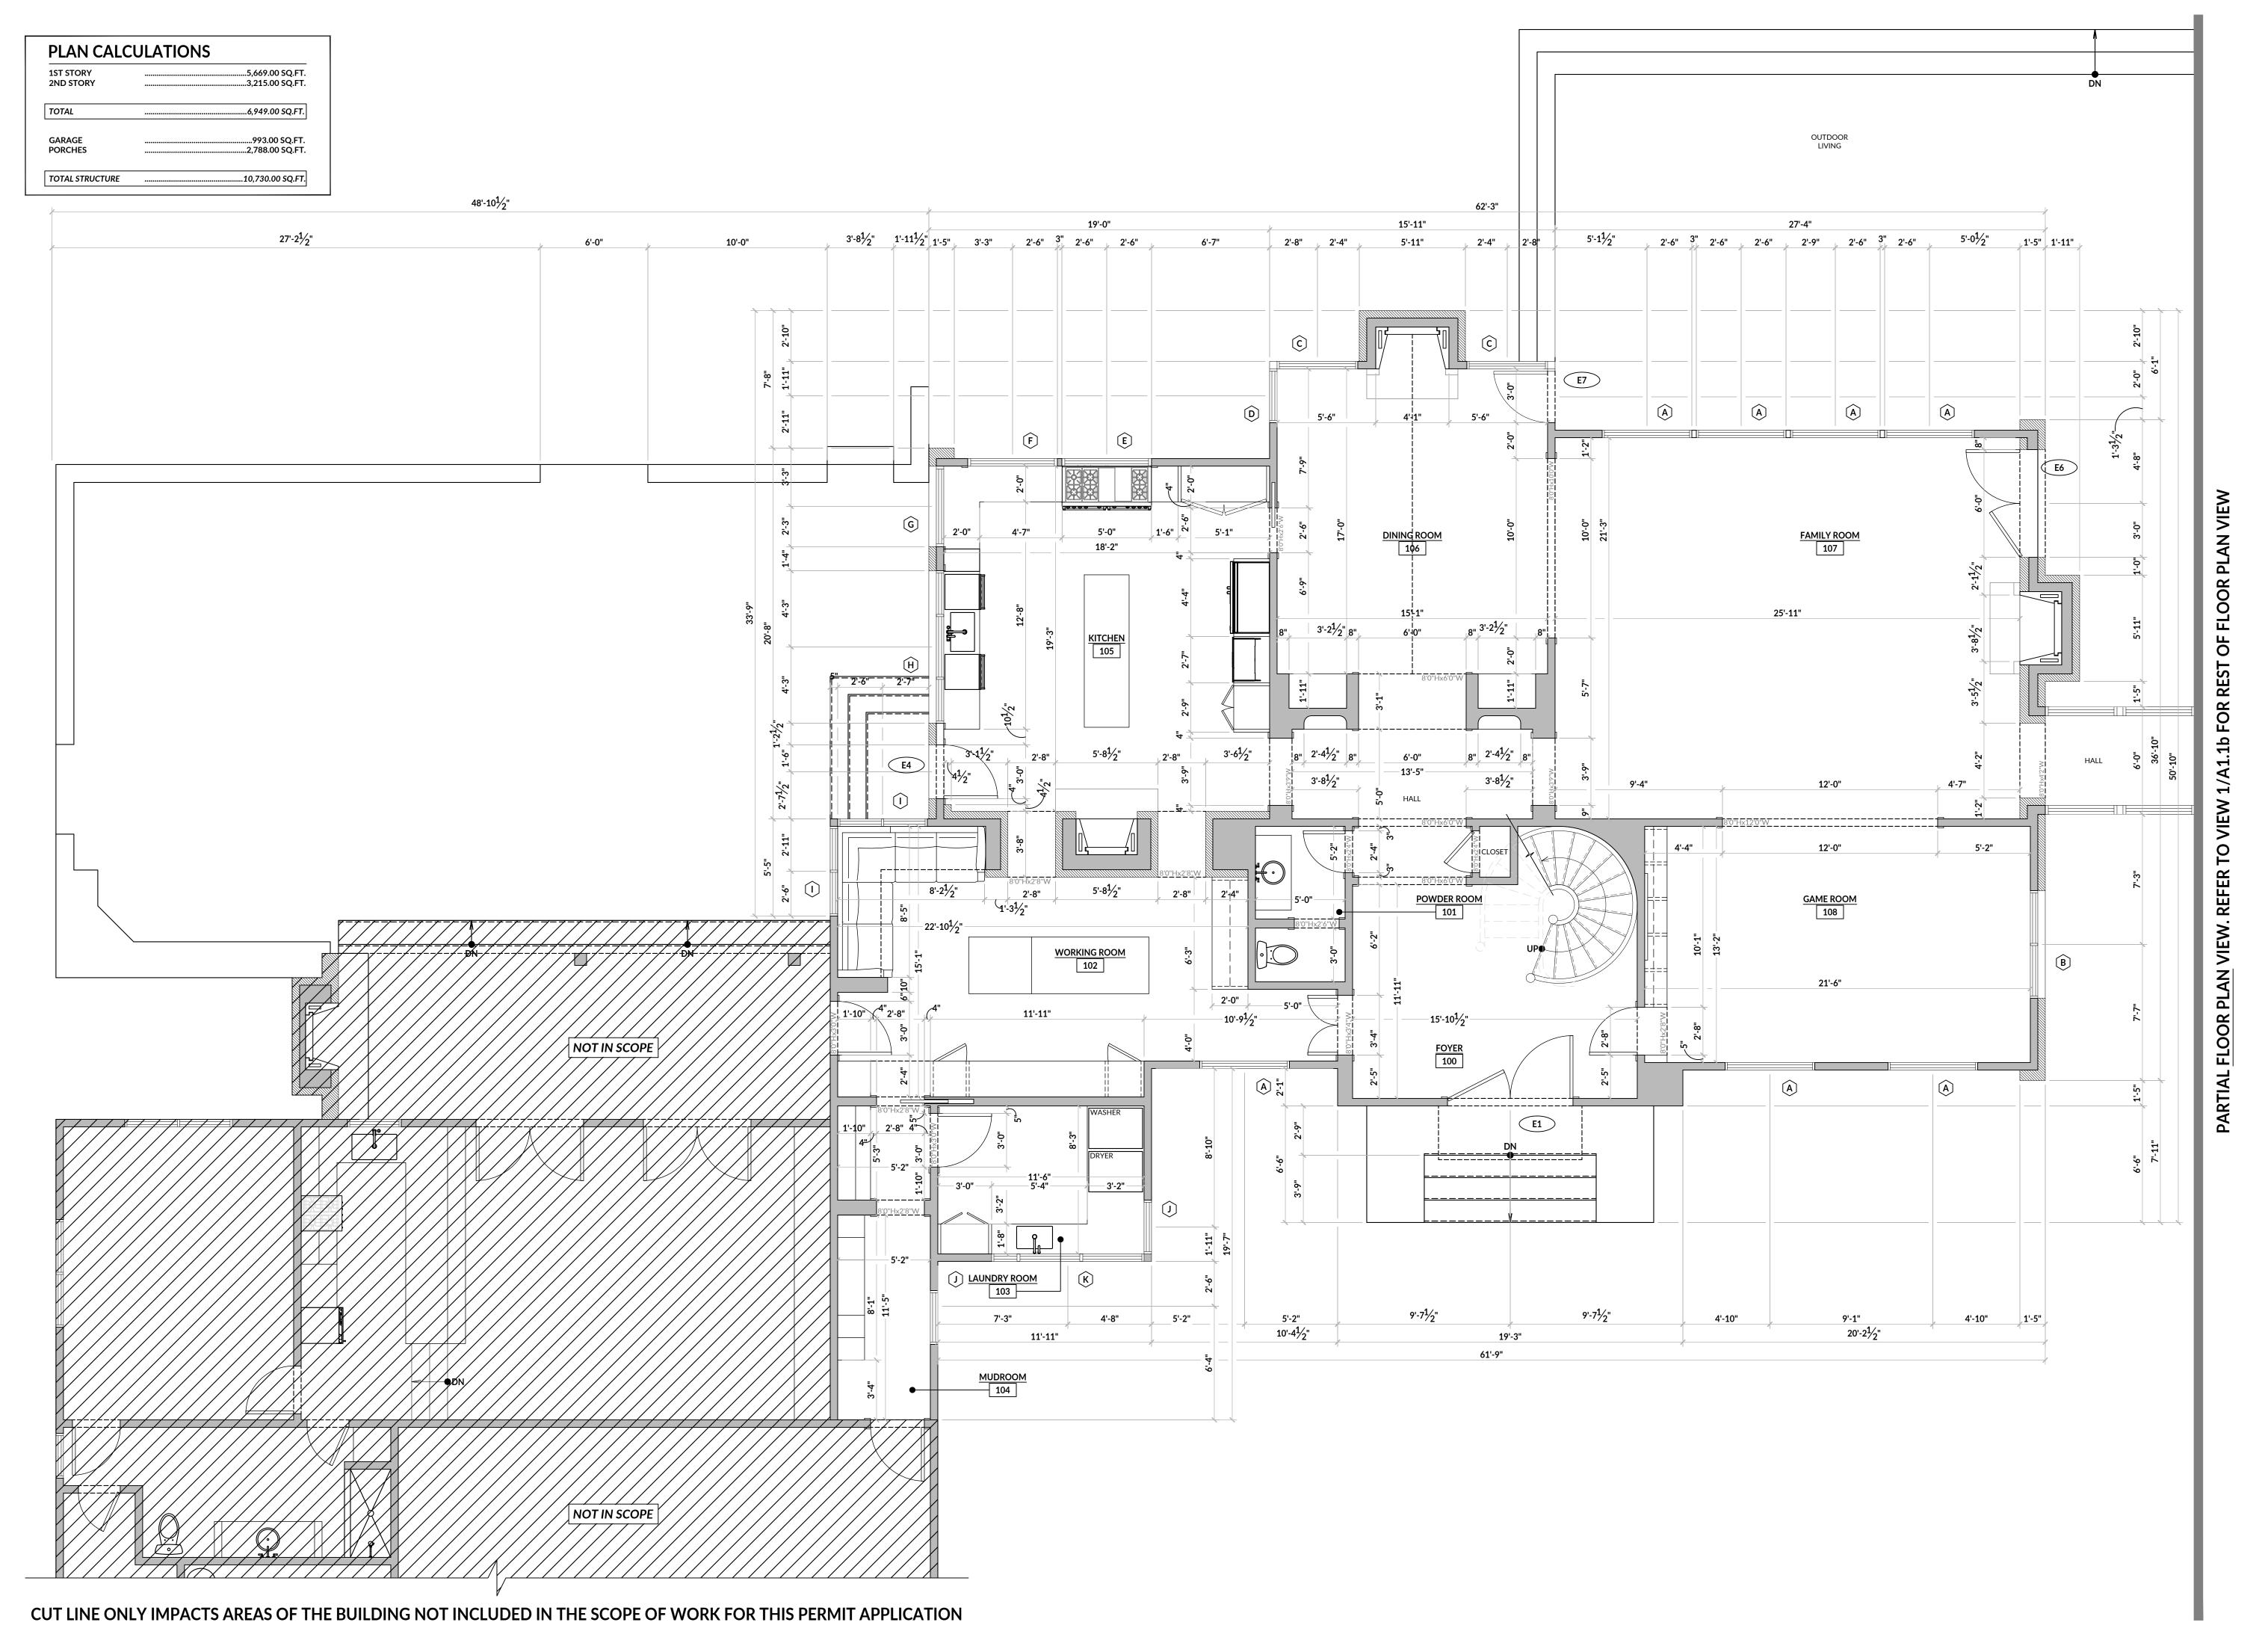

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Date: 5.1.2024

EVISIONS:

DRAWN BY:

LB

PROJECT NO:

24004

PROJECT ISSUE DATE:

DRAWING TITLE:

1ST FLOOR PLAN

TBD


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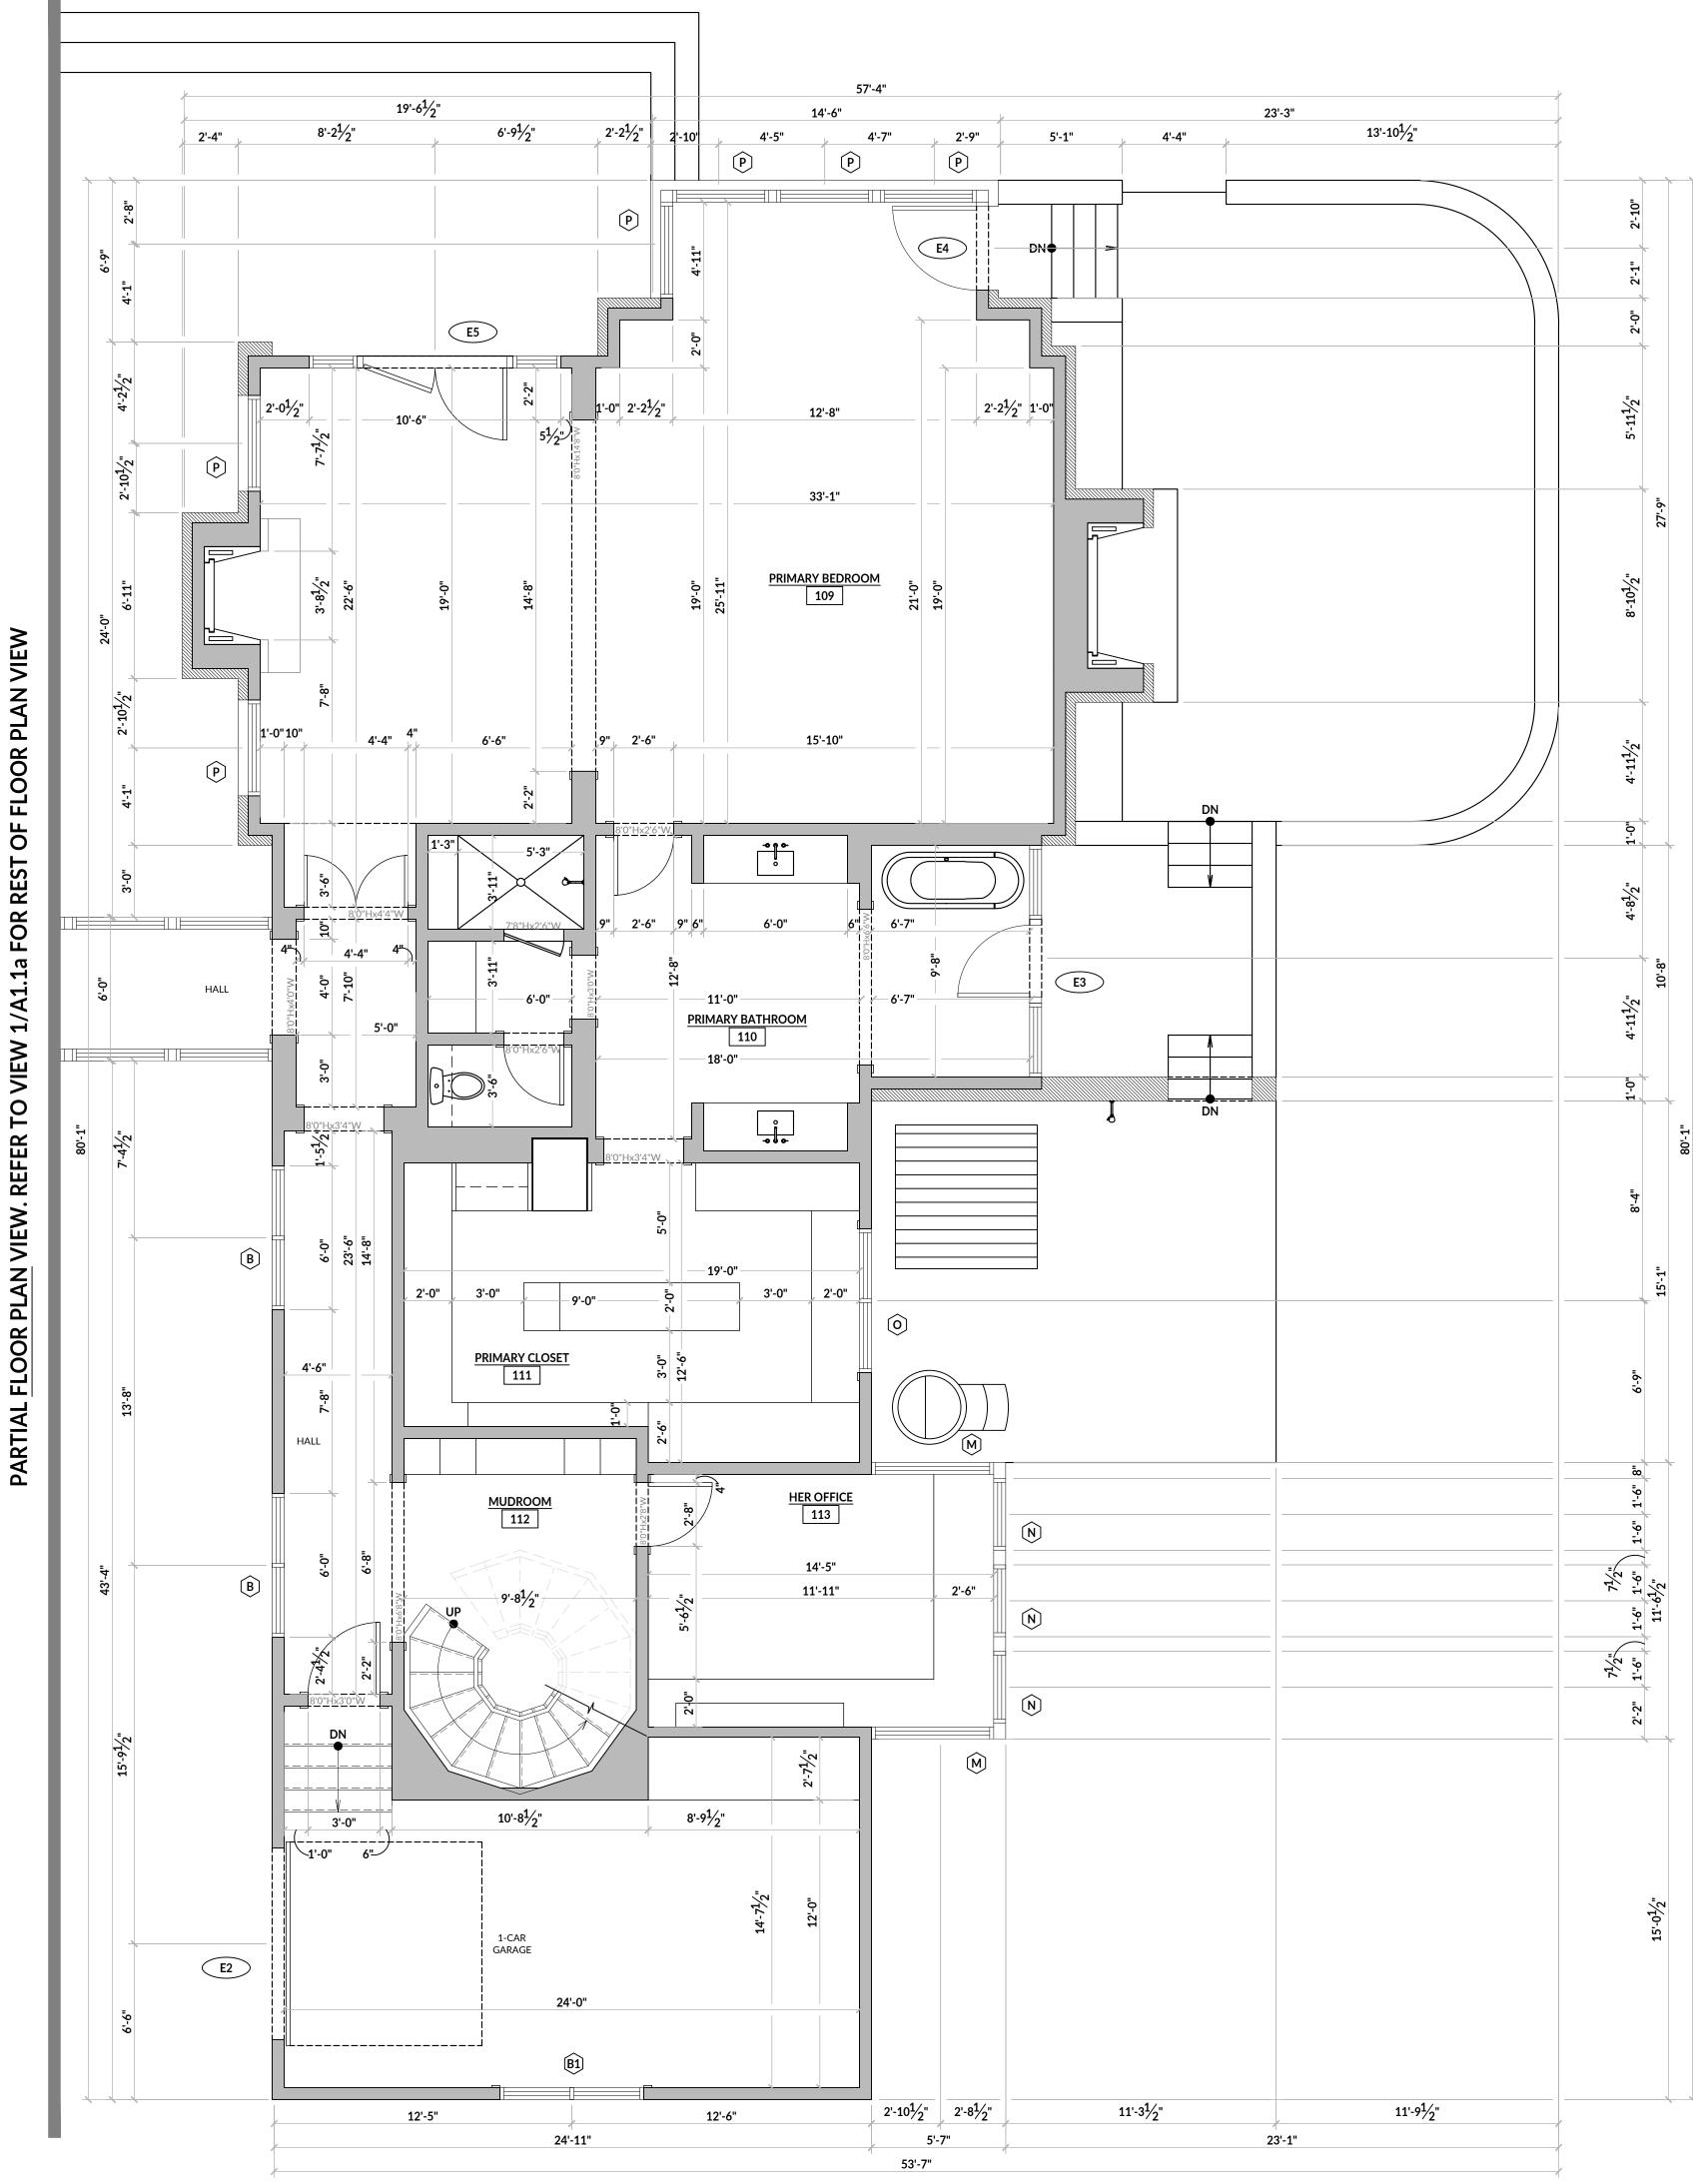
A1 1a

FIRST FLOOR PLAN - DIMENSIONS
SCALE: 0' - 1/4" = 1' - 0"

8' 16'

PLAN CALCULATIONS 1ST STORY .5,669.00 SQ.FT. 2ND STORY .3,215.00 SQ.FT. TOTAL .6,949.00 SQ.FT. GARAGE .993.00 SQ.FT. PORCHES .2,788.00 SQ.FT. TOTAL STRUCTURE .10,730.00 SQ.FT.



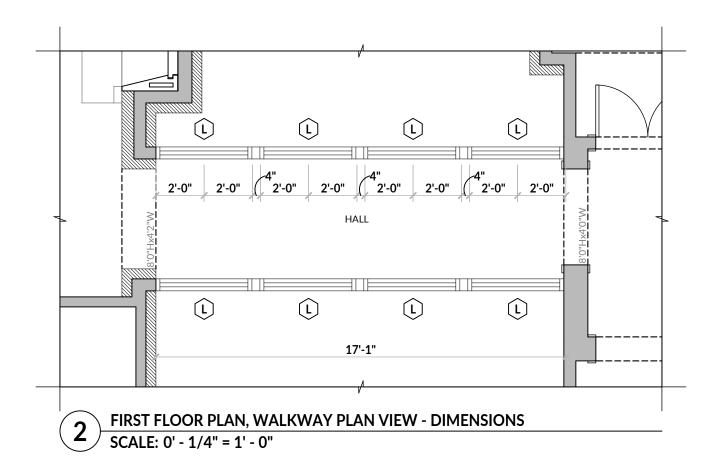

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REVISIONS:

DRAWN BY:
PROJECT NO:

PROJECT ISSUE DATE:

DRAWING TITLE

1ST FLOOR PLAN

24004


TBD

SCALE: As indicated

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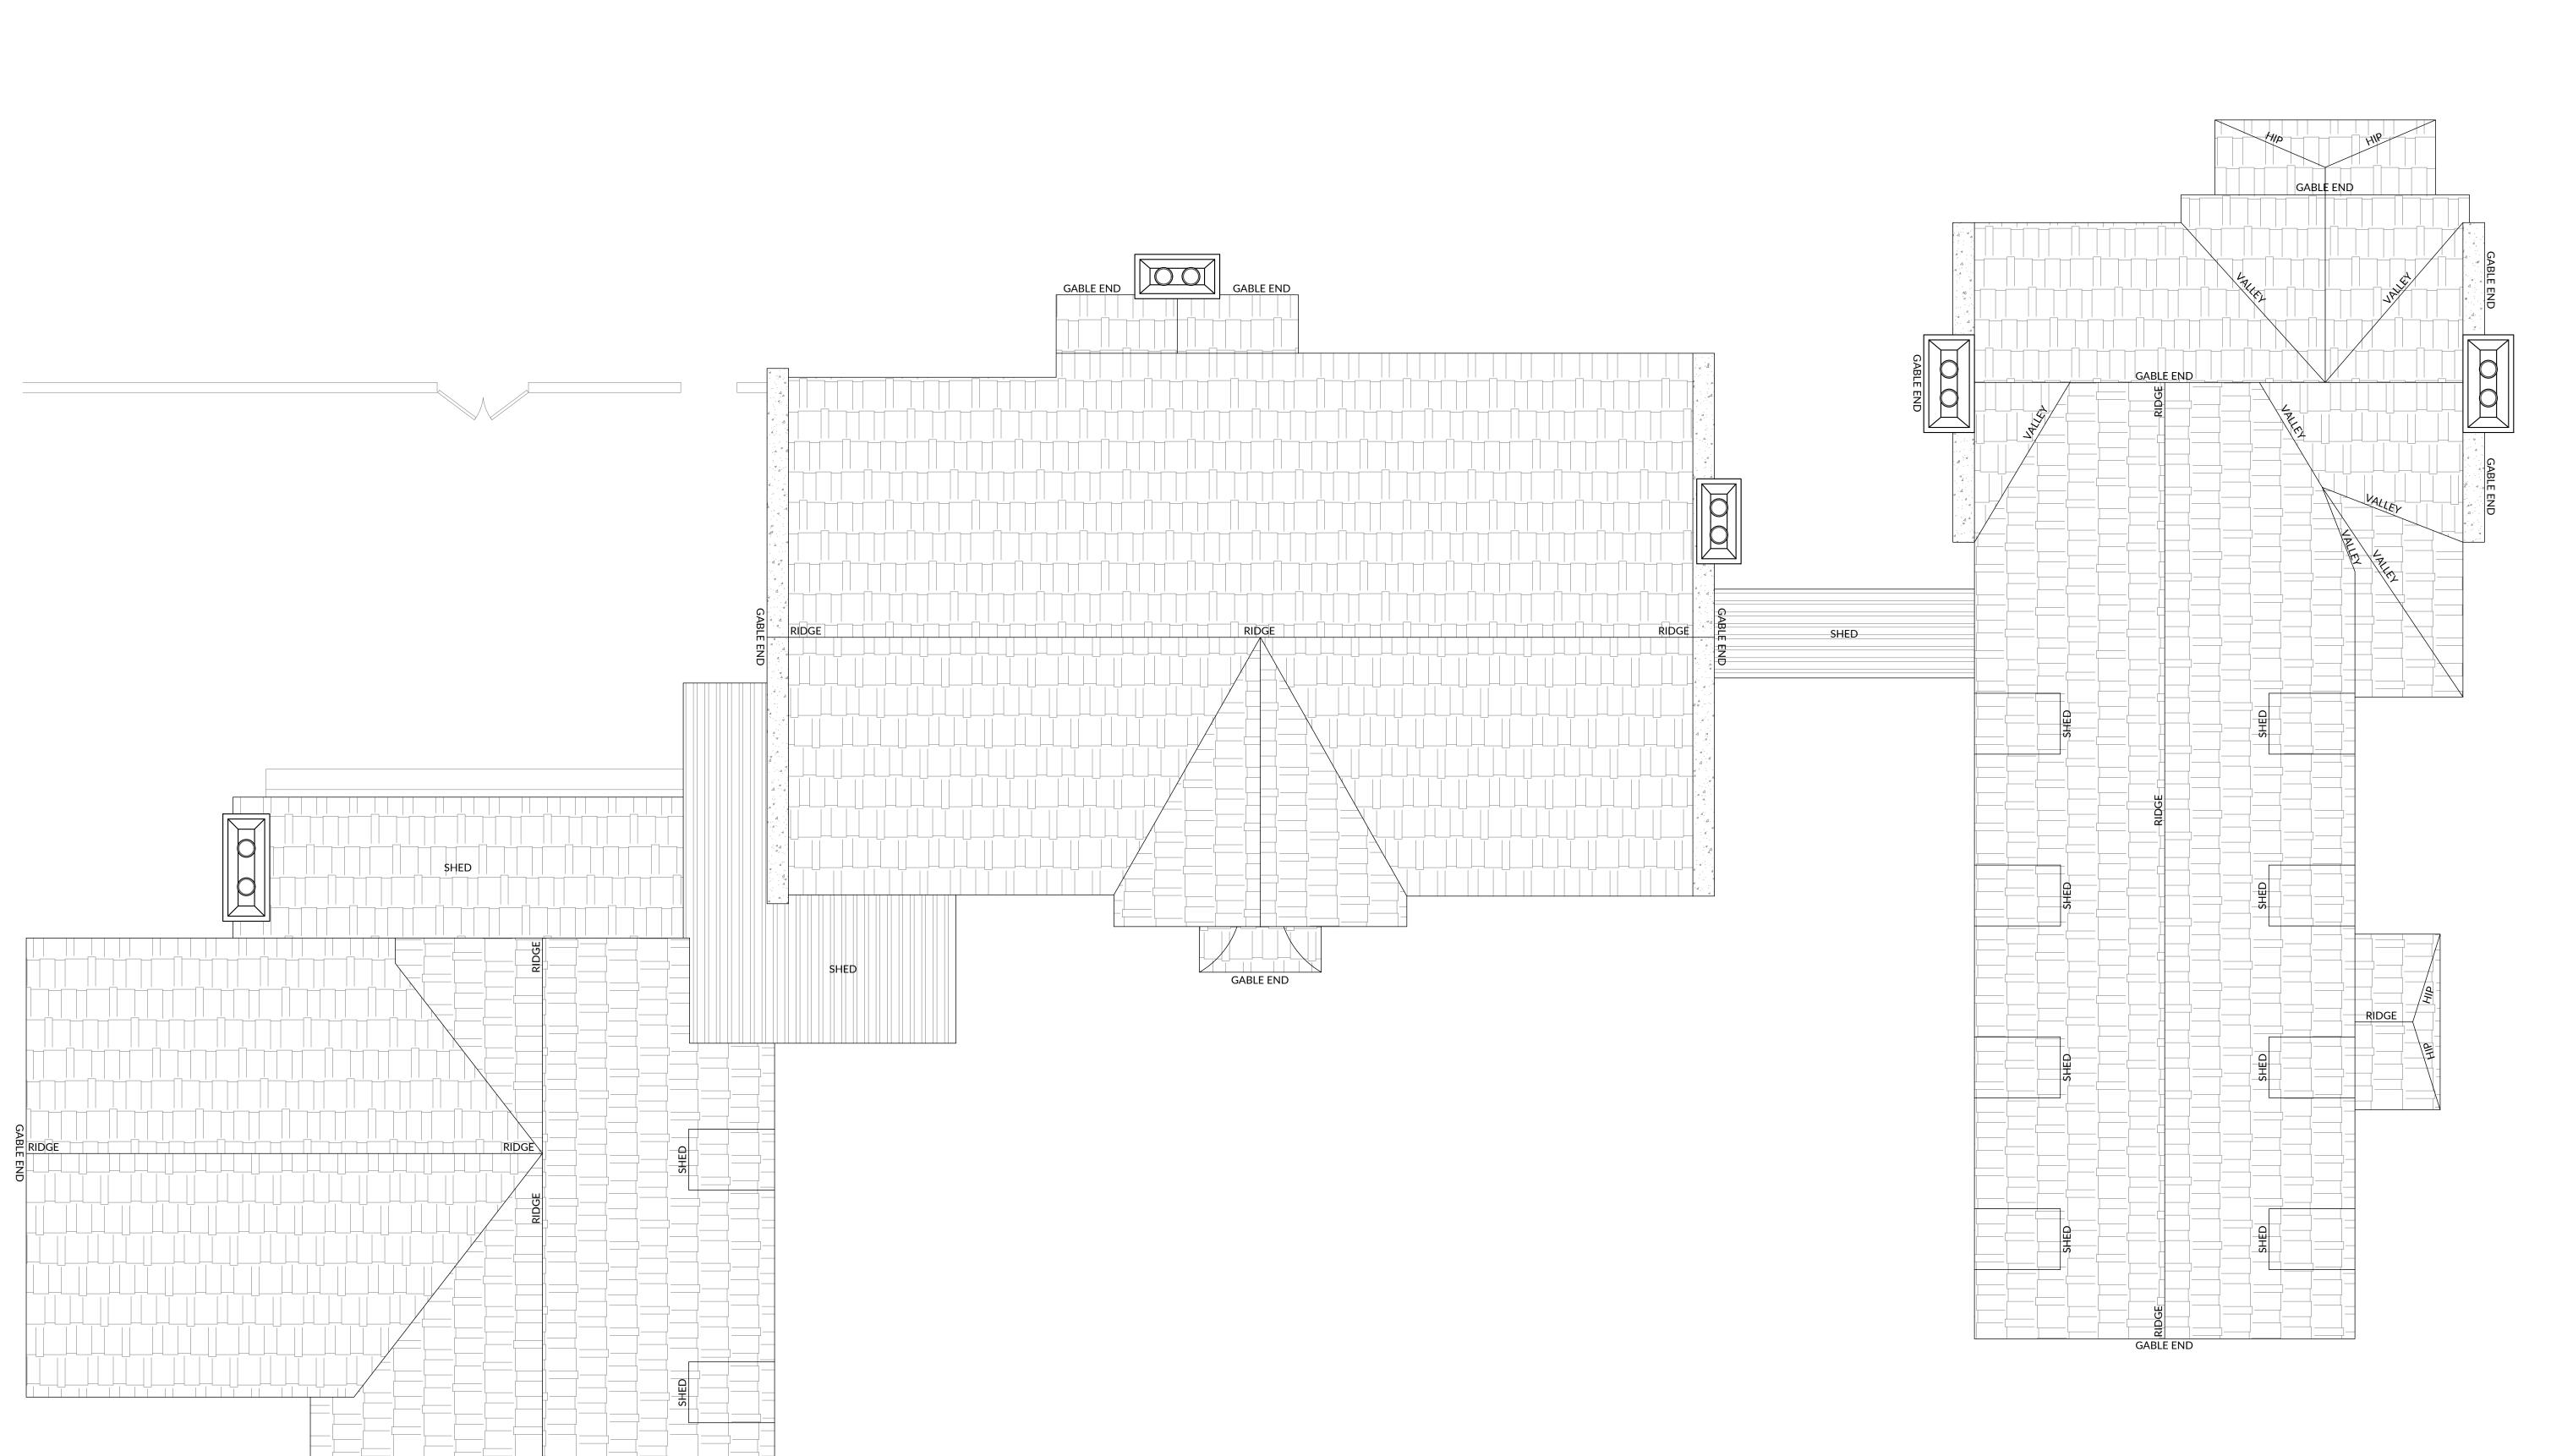
53'-7"

| FIRST FLOOR PLAN - DIMENSIONS | 16' | SCALE: 0' - 1/4" = 1' - 0"

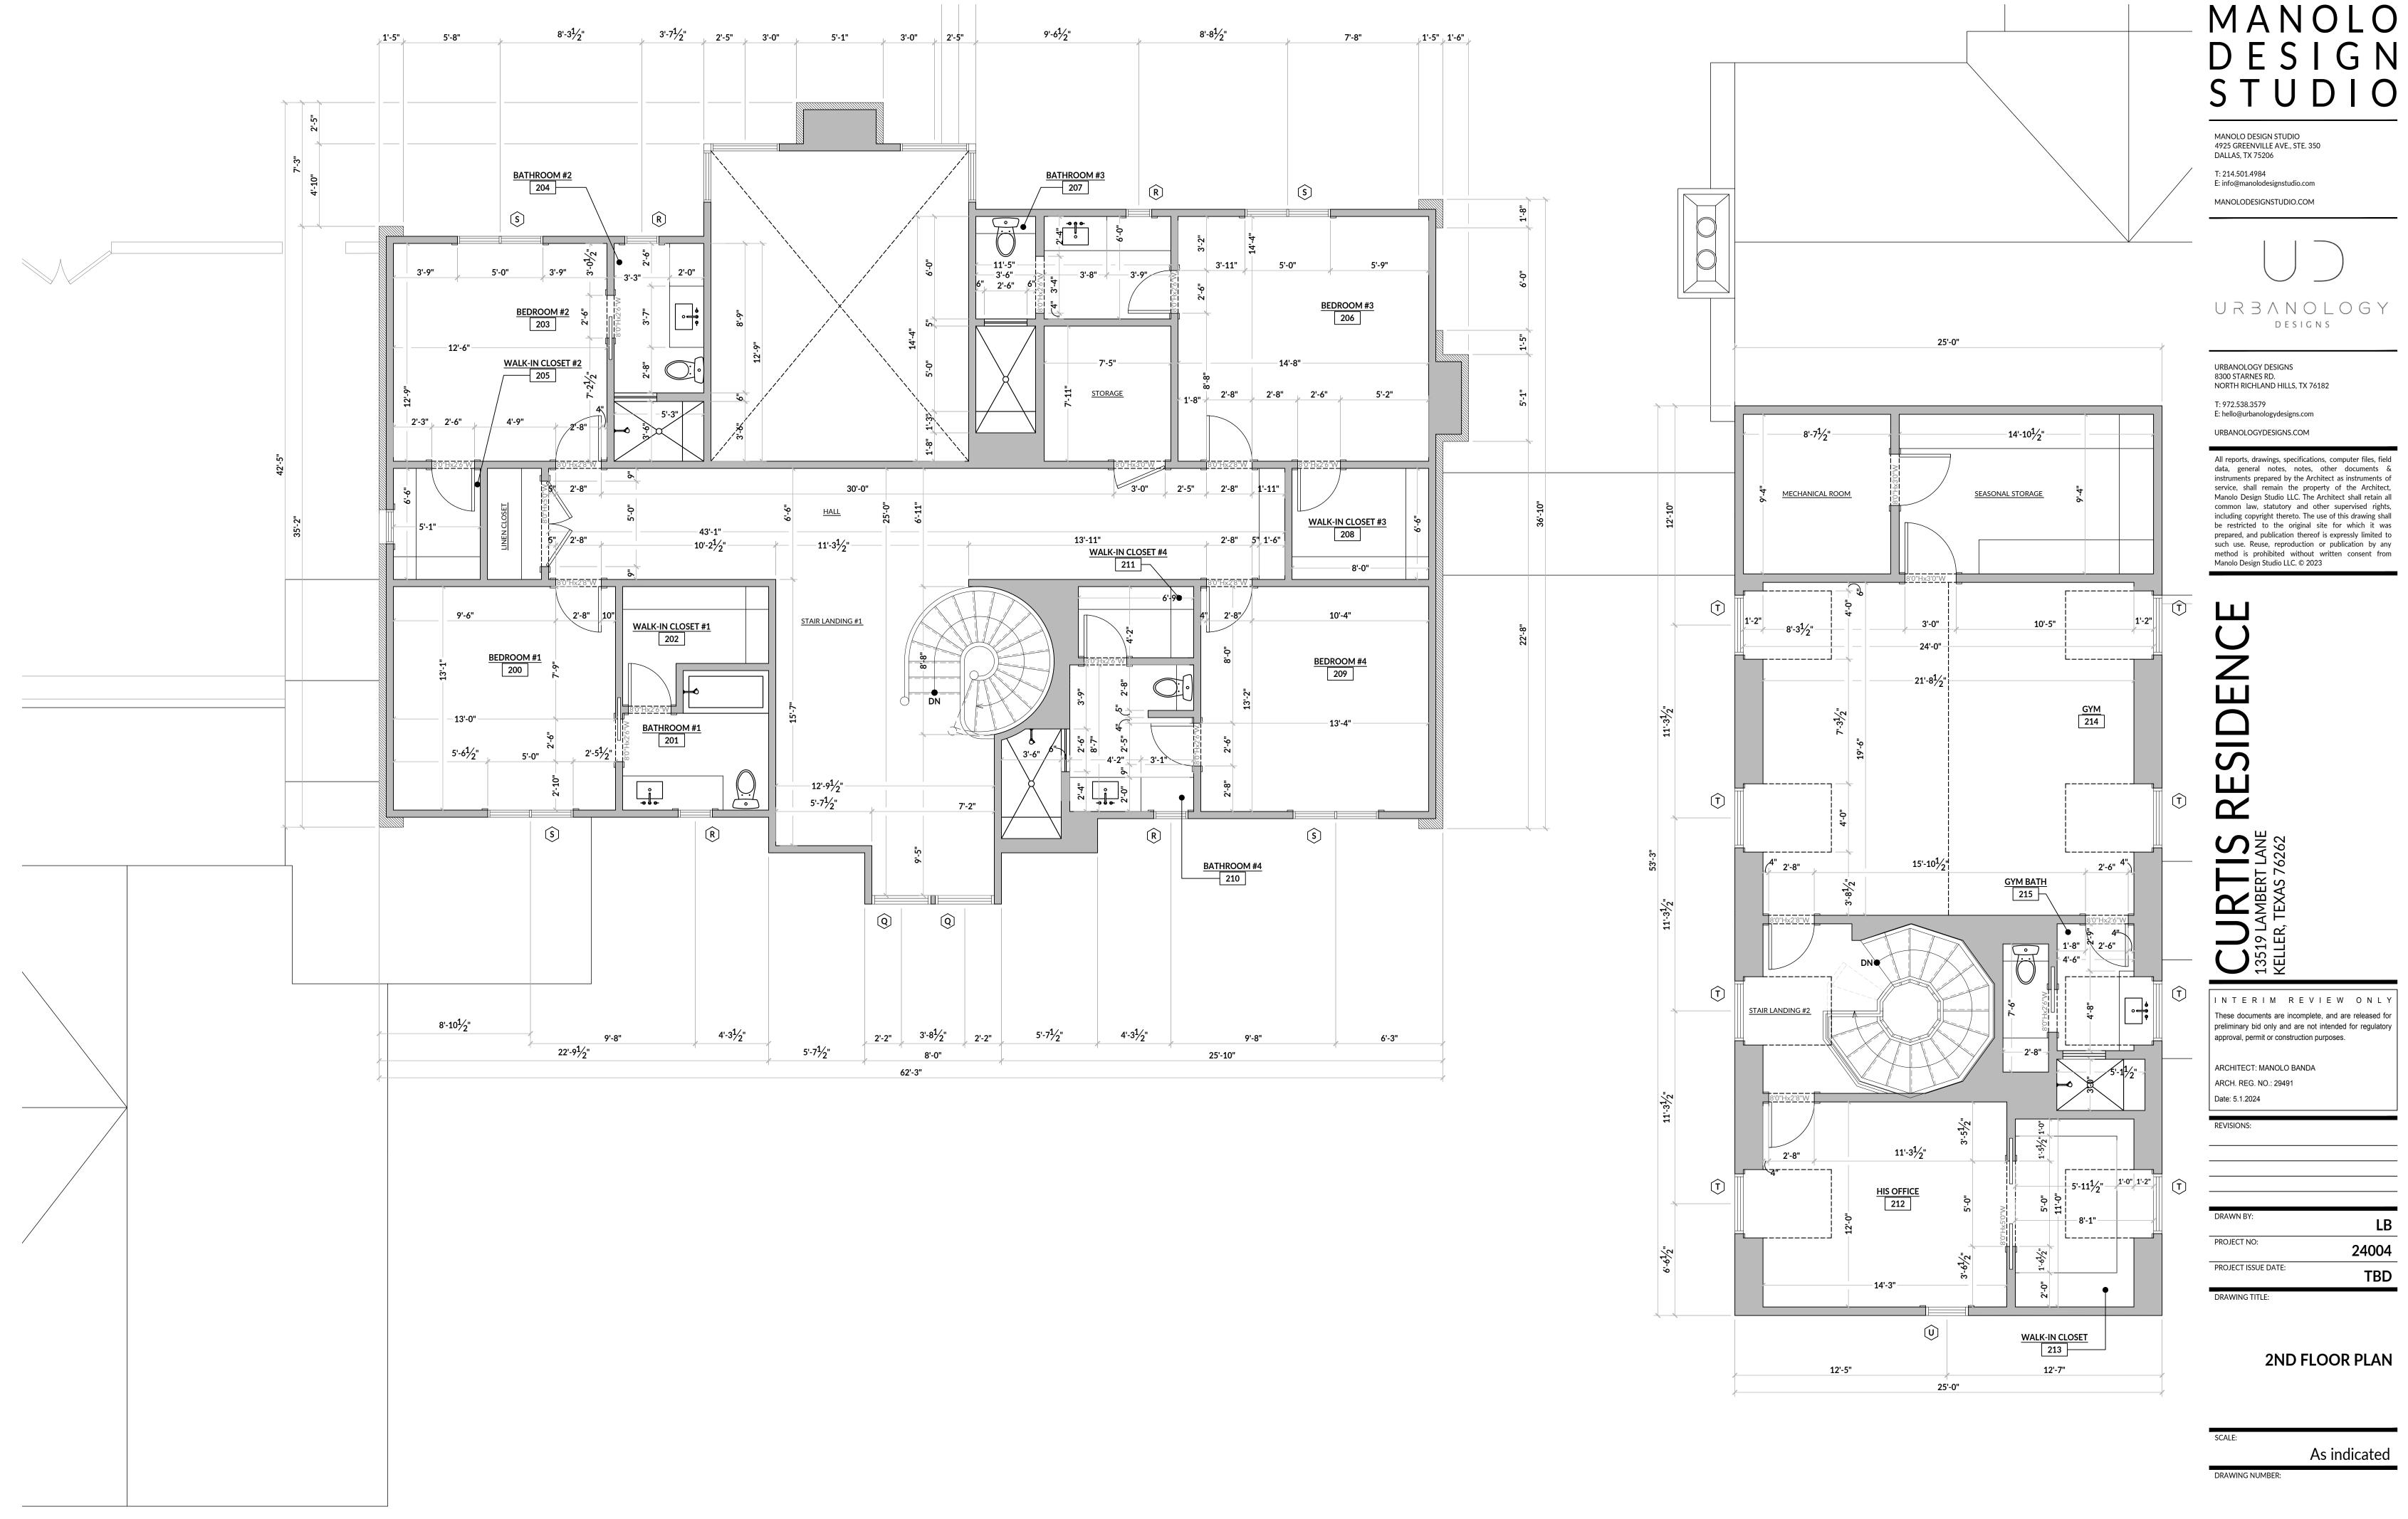

SECOND FLOOR PLAN - DIMENSIONS

SCALE: 0' - 1/4" = 1' - 0"



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Date: 5.1.2024

REVISIONS:

DRAWN BY:

LB

PROJECT NO:

24004

PROJECT ISSUE DATE:


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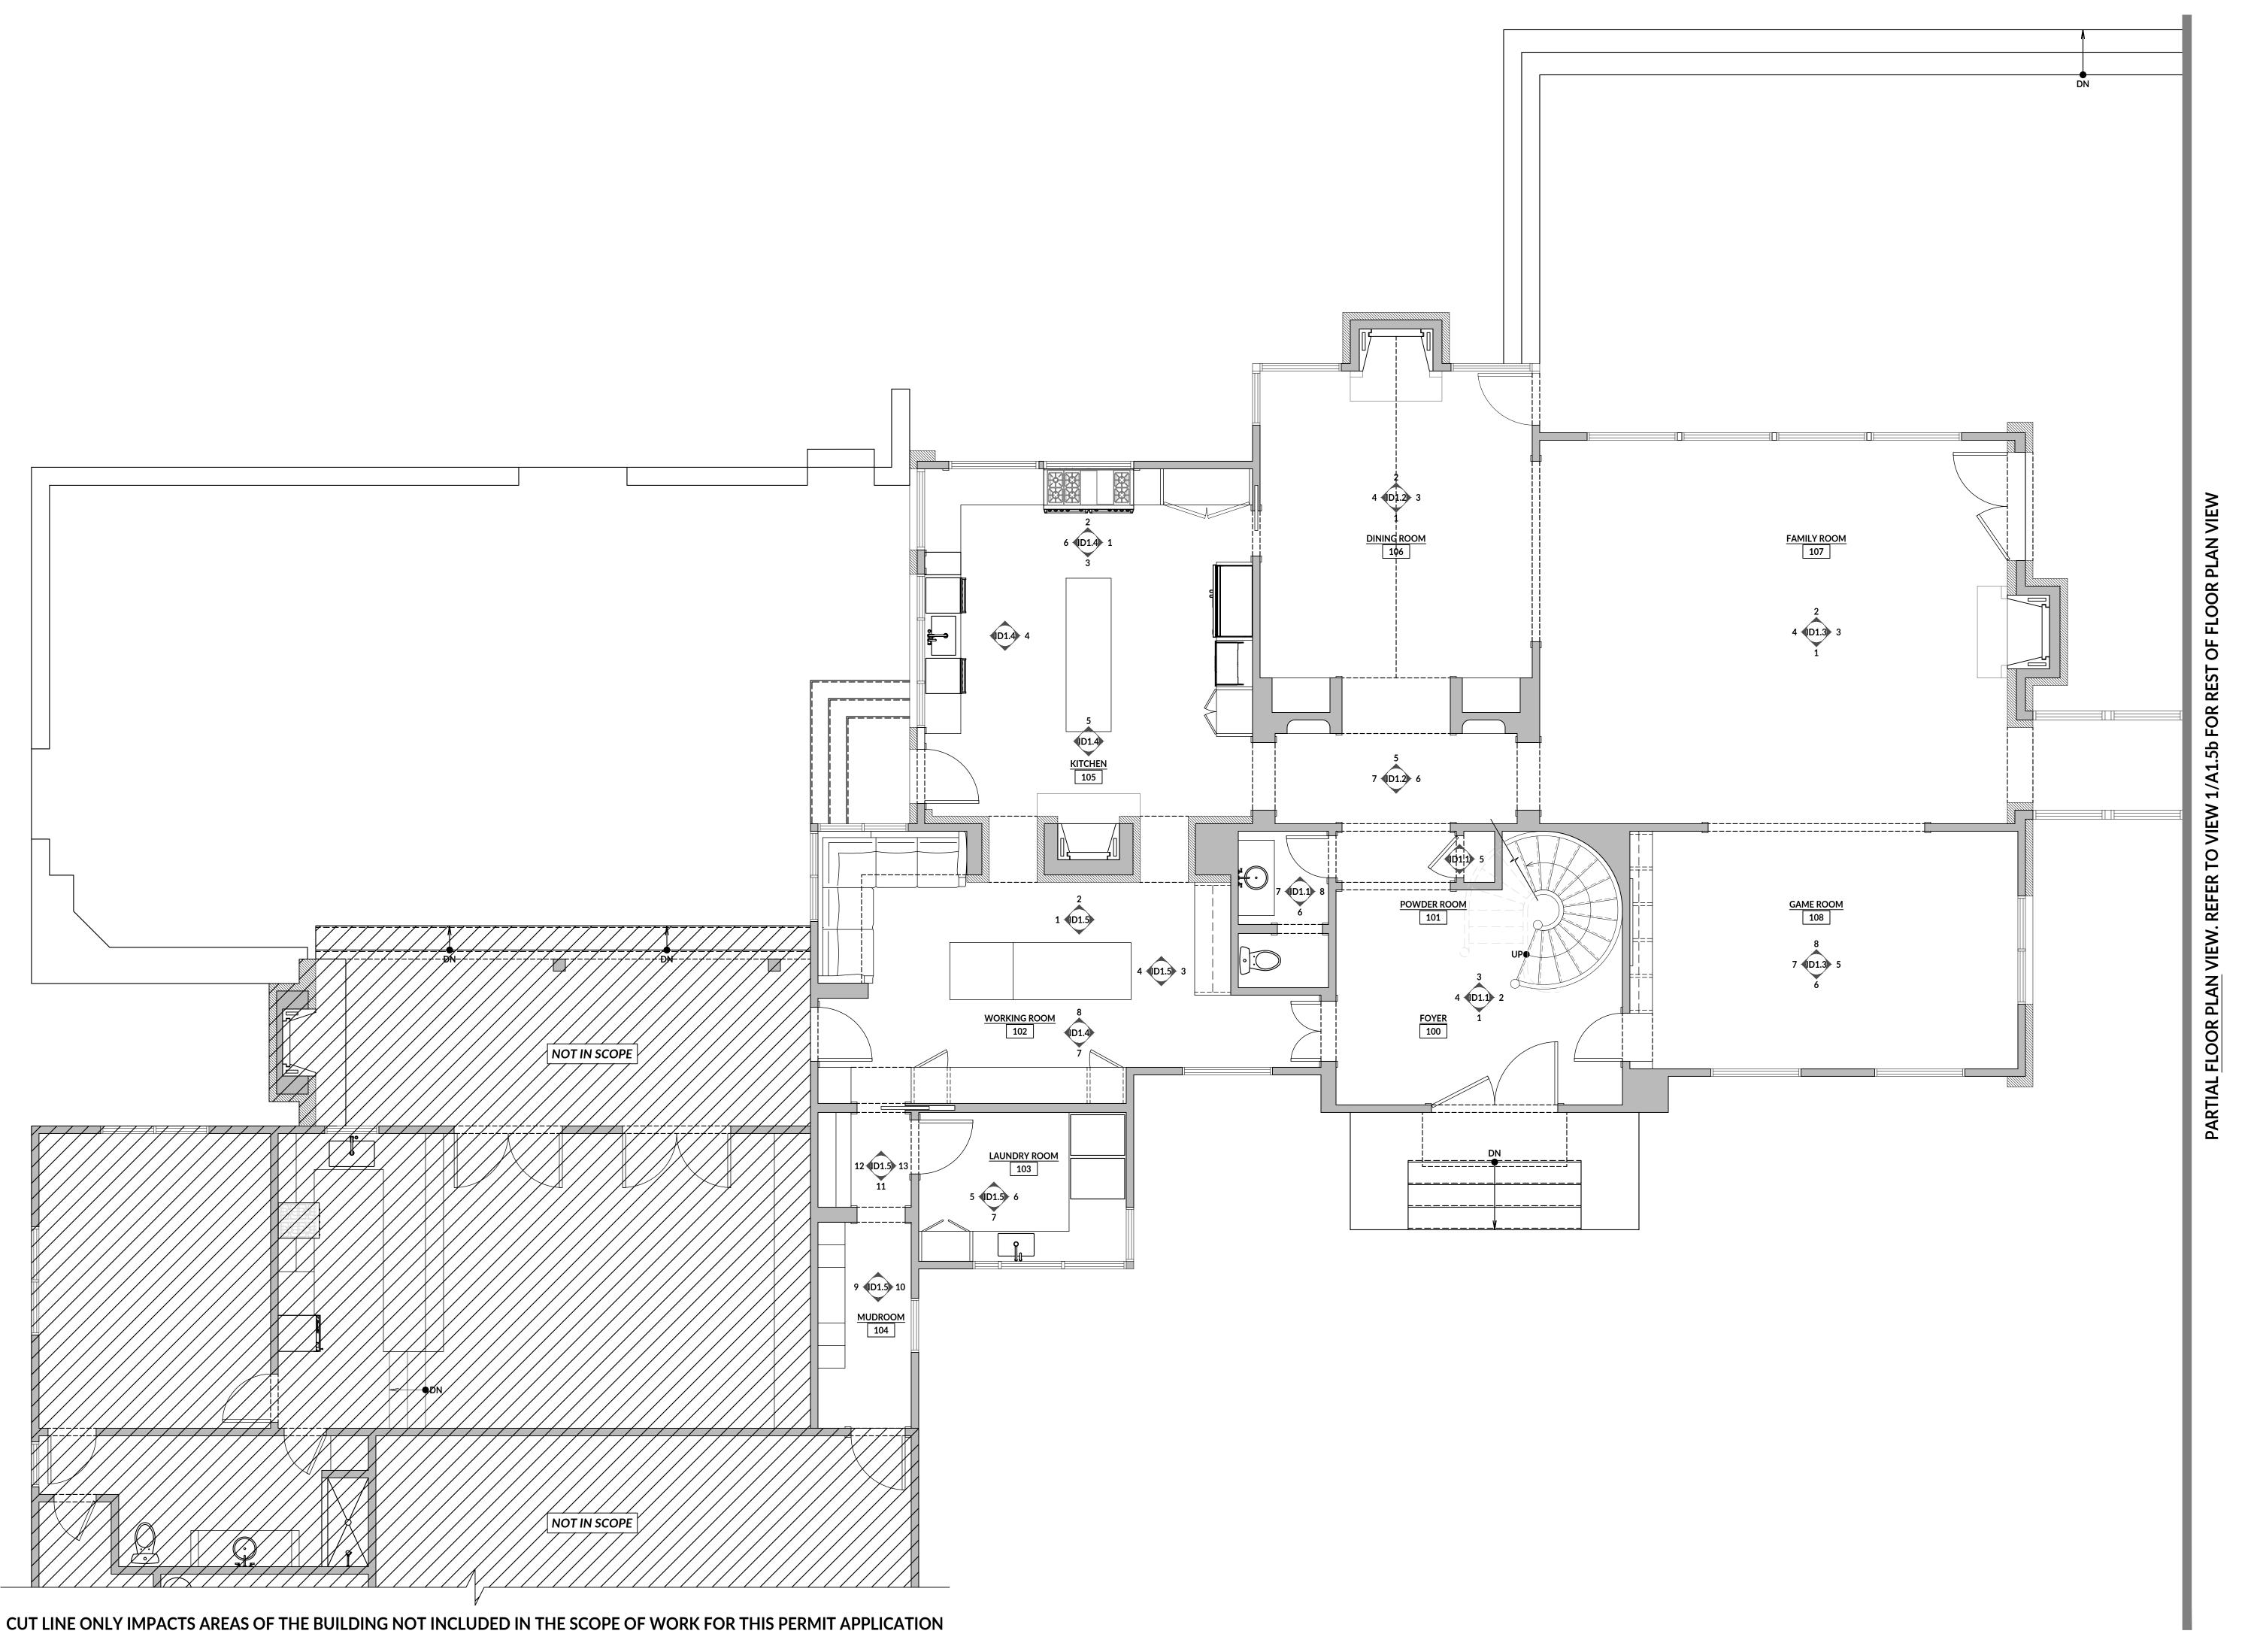
ROOF FLOOR PLAN

TBD

As indicated

A1.4



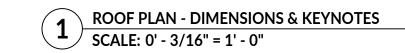

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ARCHITECT: MANOLO BANDA ARCH. REG. NO.: 29491 Date: 5.1.2024

24004

PROJECT ISSUE DATE:


1ST FLOOR PLAN KEYNOTES & CONSTRUCTION NOTES

TBD

As indicated

FIRST FLOOR PLAN - KEYNOTES & CONSTRUCTION NOTES

SCALE: 0' - 1/4" = 1' - 0"

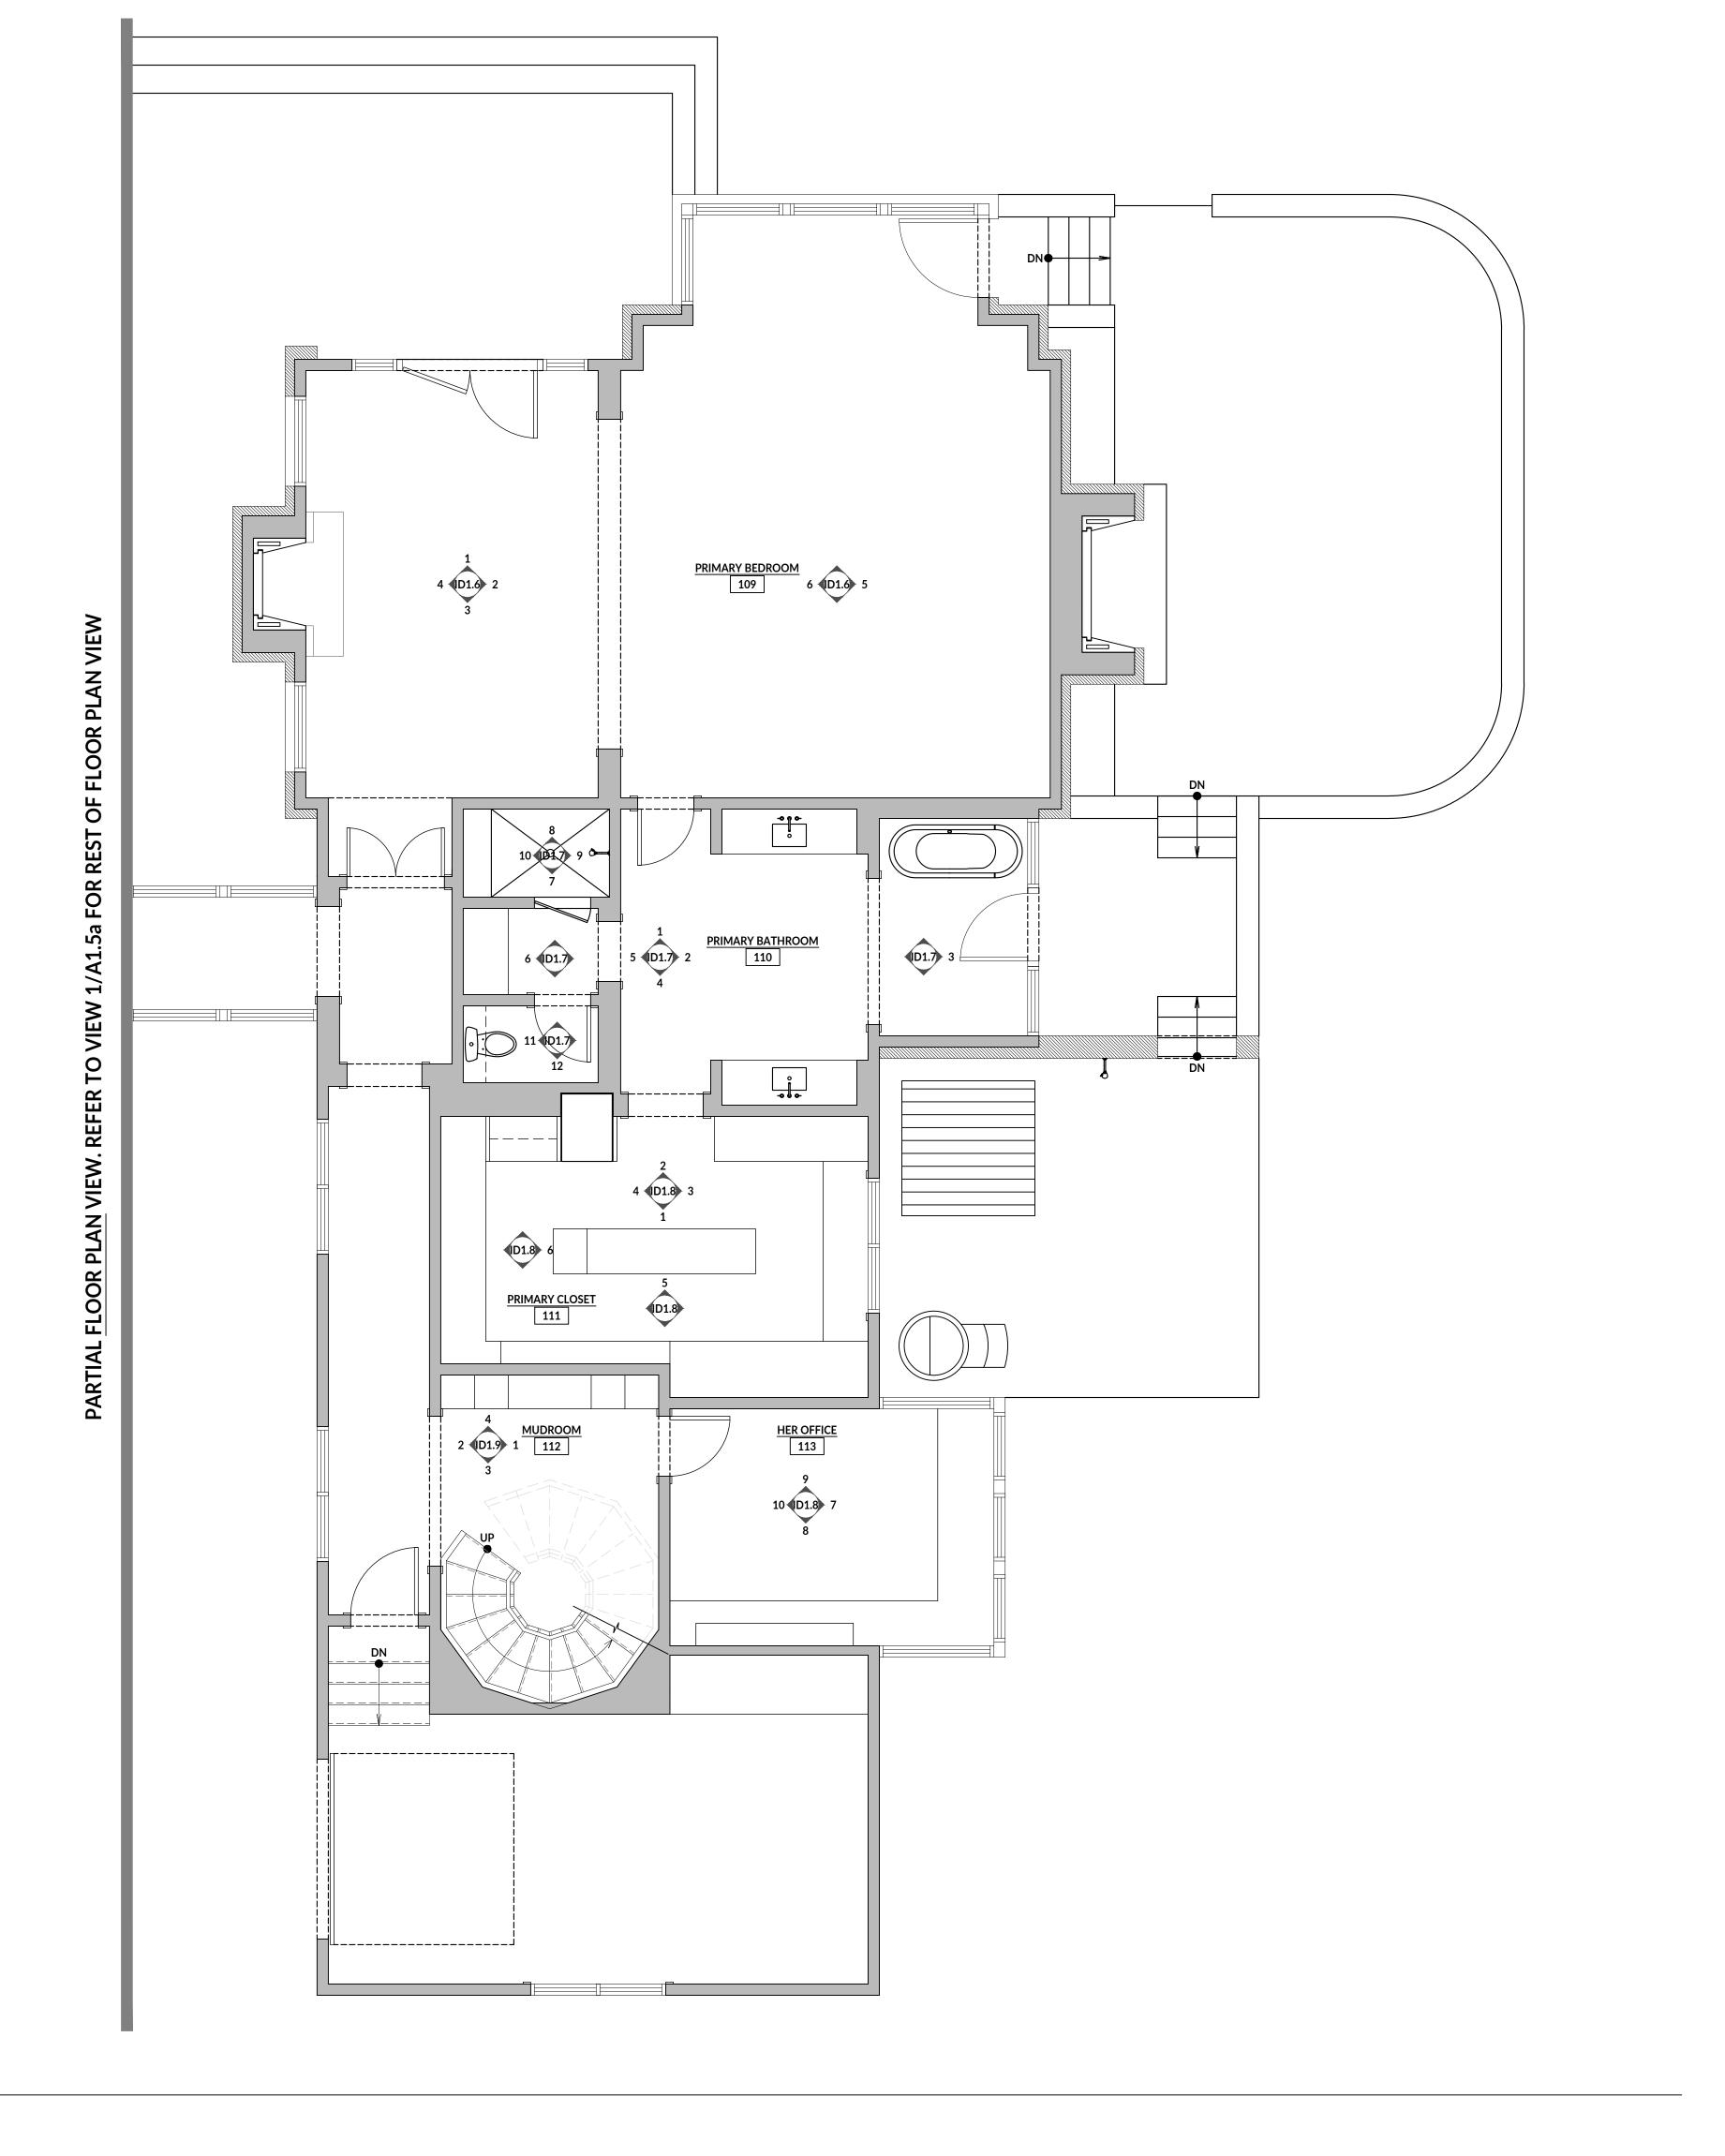

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ARCH. REG. NO.: 29491
Date: 5.1.2024

REVISIONS:

DRAWN BY:

LB

PROJECT NO:

24004

PROJECT ISSUE DATE:

DRAWING TITLE


1ST FLOOR PLAN KEYNOTES & CONSTRUCTION NOTES

TBD


CALE:
As indicated

DRAWING NUM

A1.5b

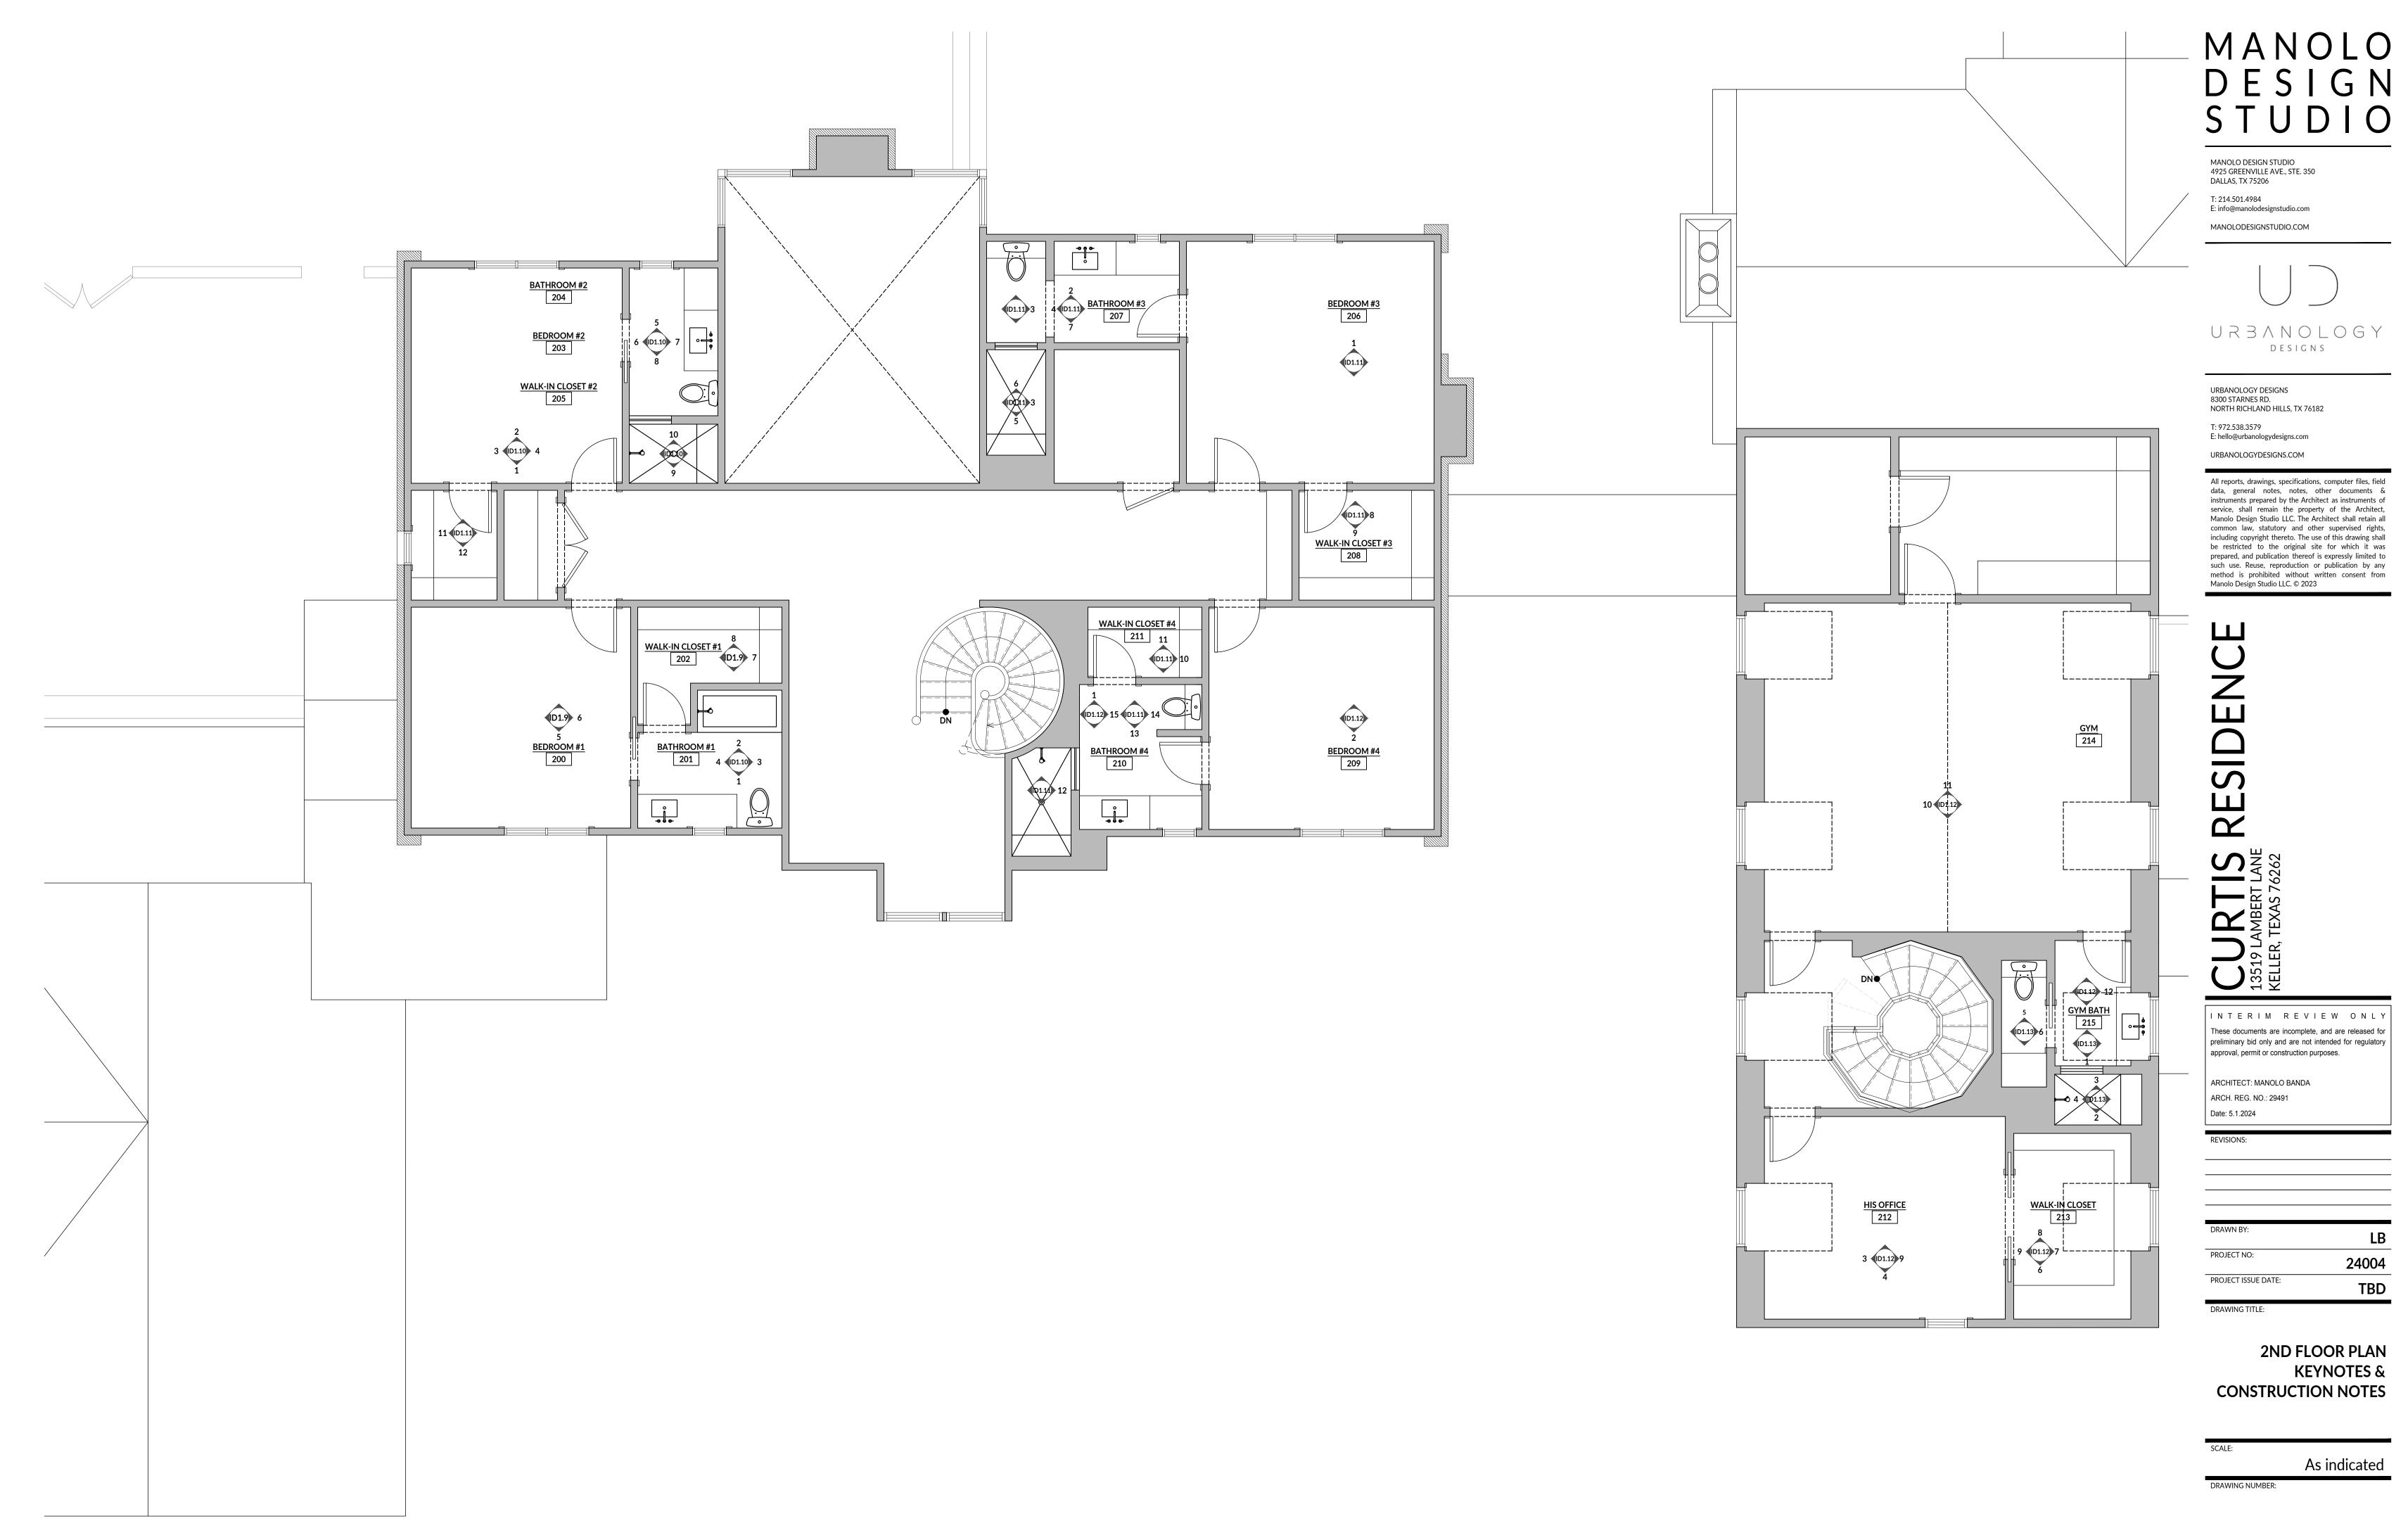

A1.6

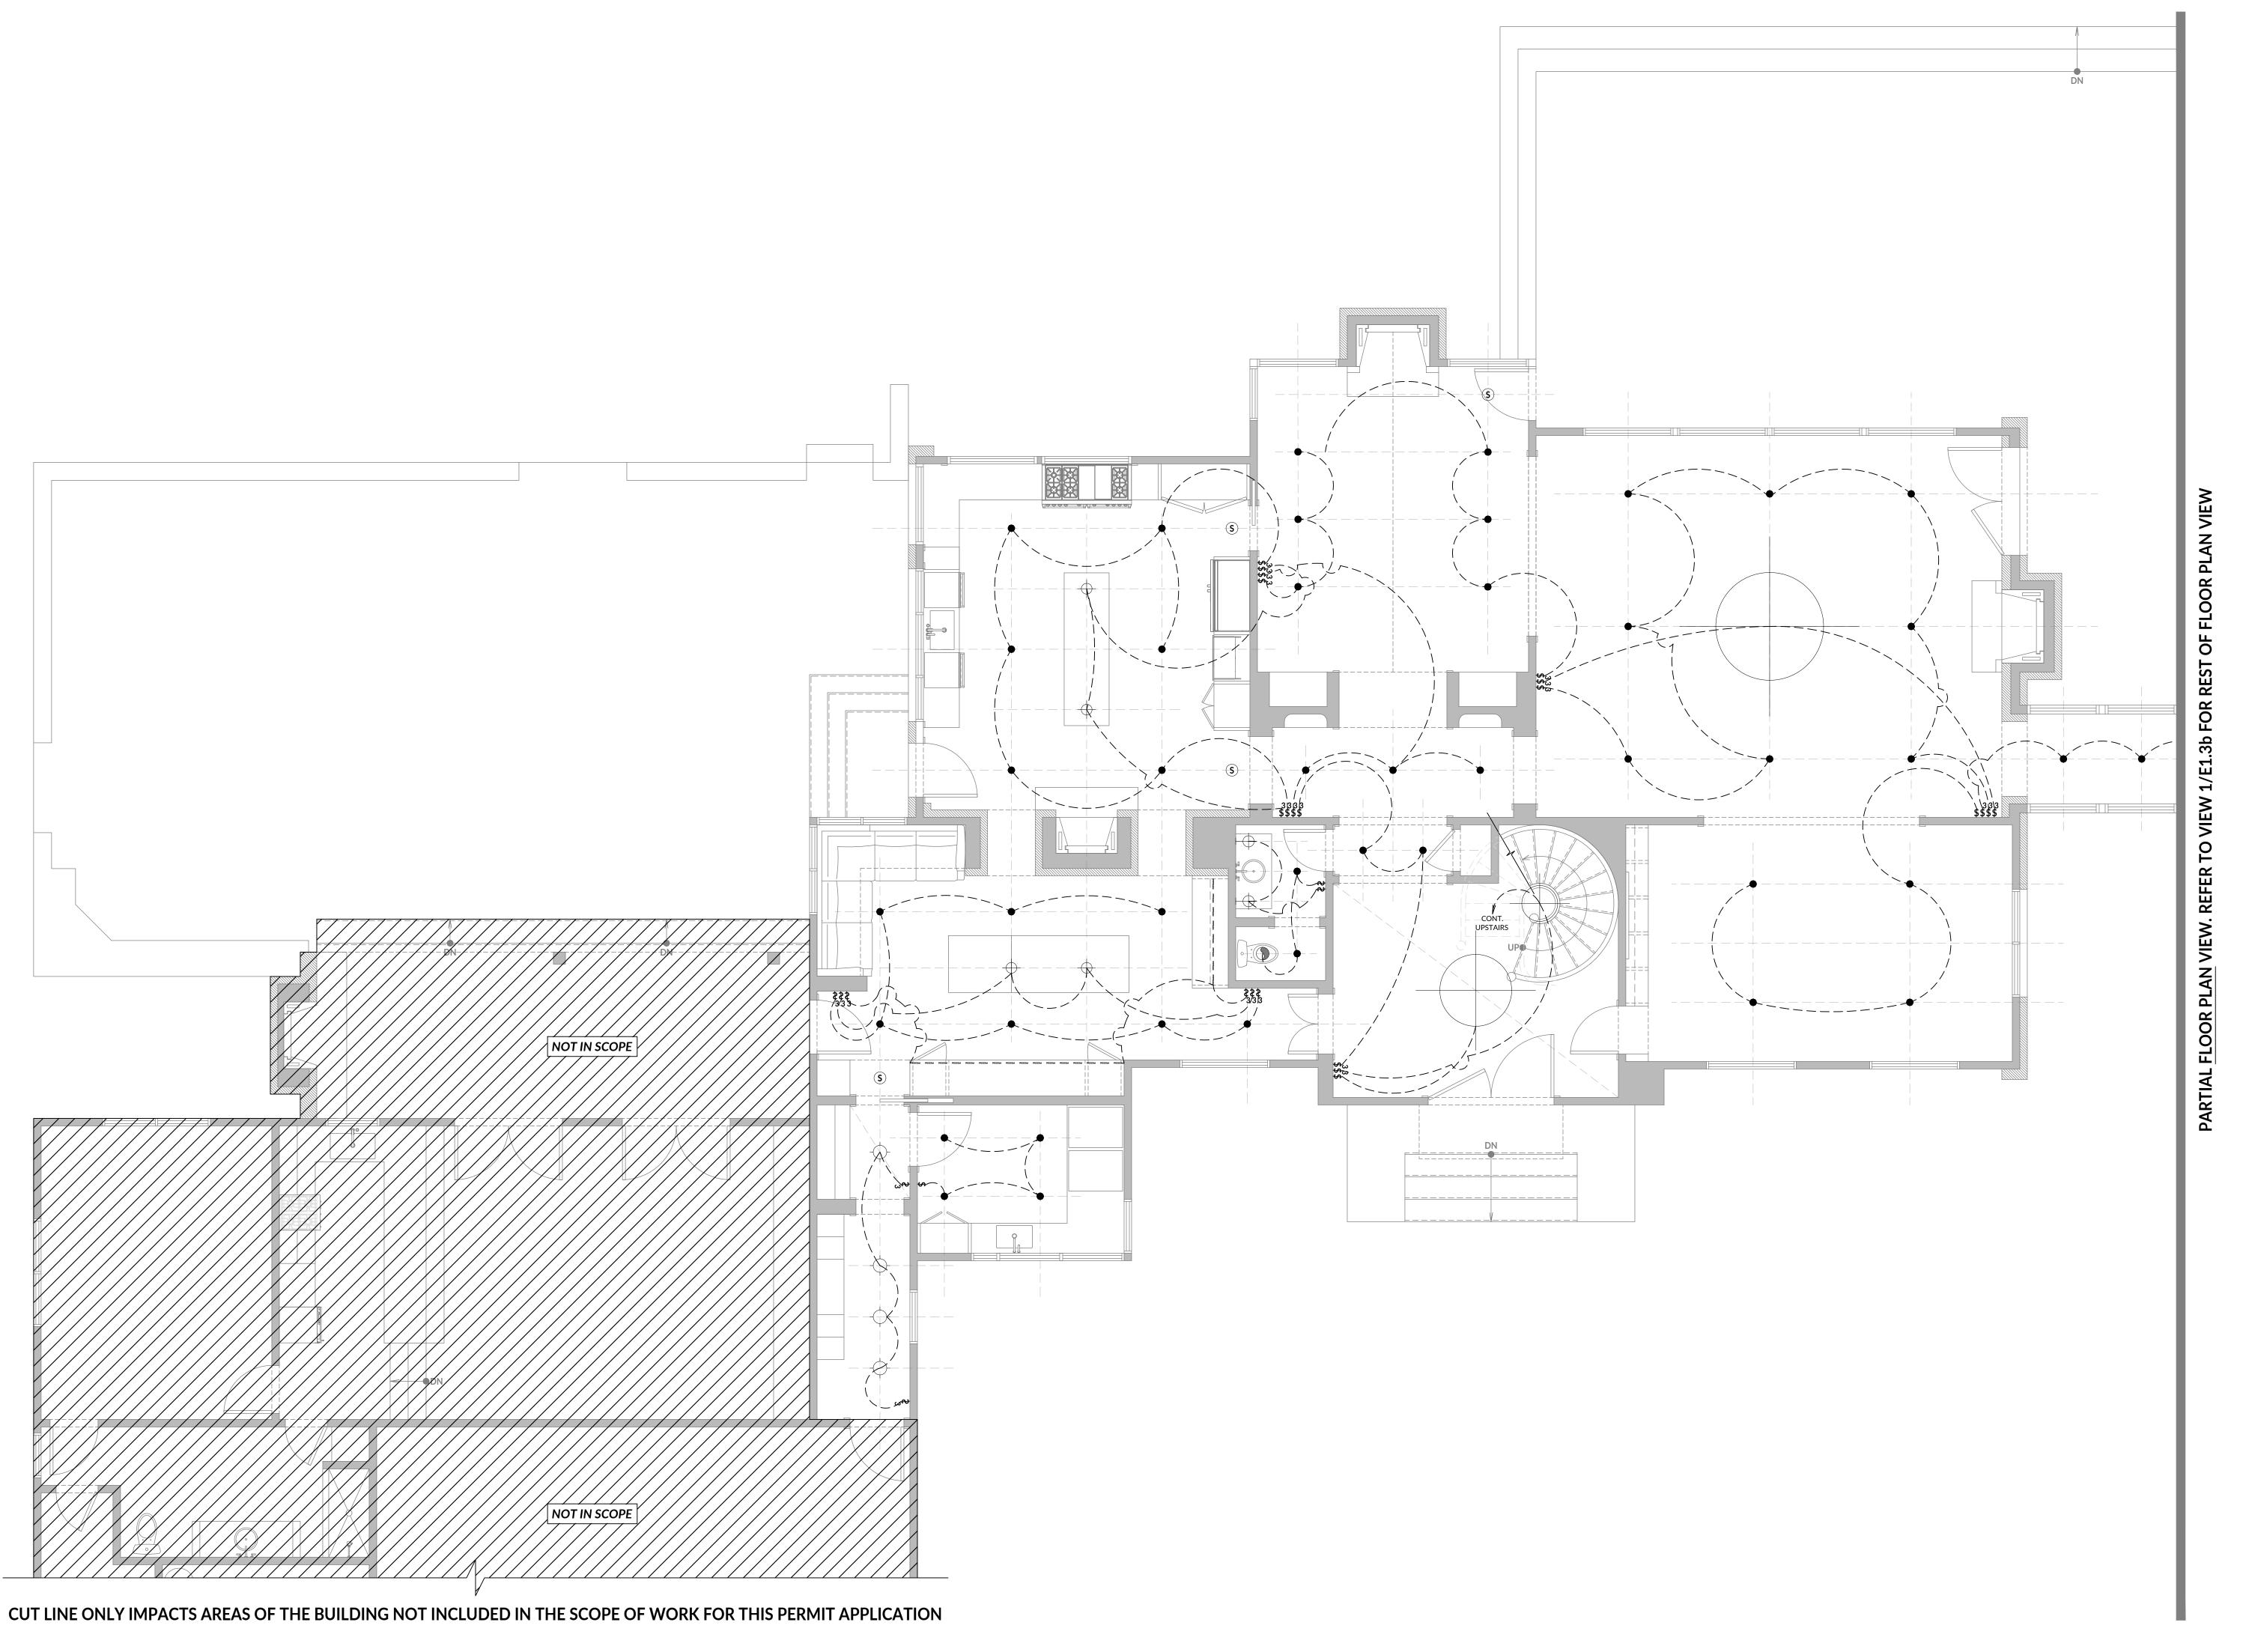

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ARCH. REG. NO.: 29491
Date: 5.1.2024

DEVISIONS:

PRAWN BY:

PROJECT NO: 24004

PROJECT ISSUE DATE: TBD

DRAWING TITLE:


1ST FLOOR ELECTRICAL PLAN

As indicated

DRAWING NUMBER:

E1.1a

FIRST FLOOR PLAN - DIMENSIONS
SCALE: 0' - 1/4" = 1' - 0"

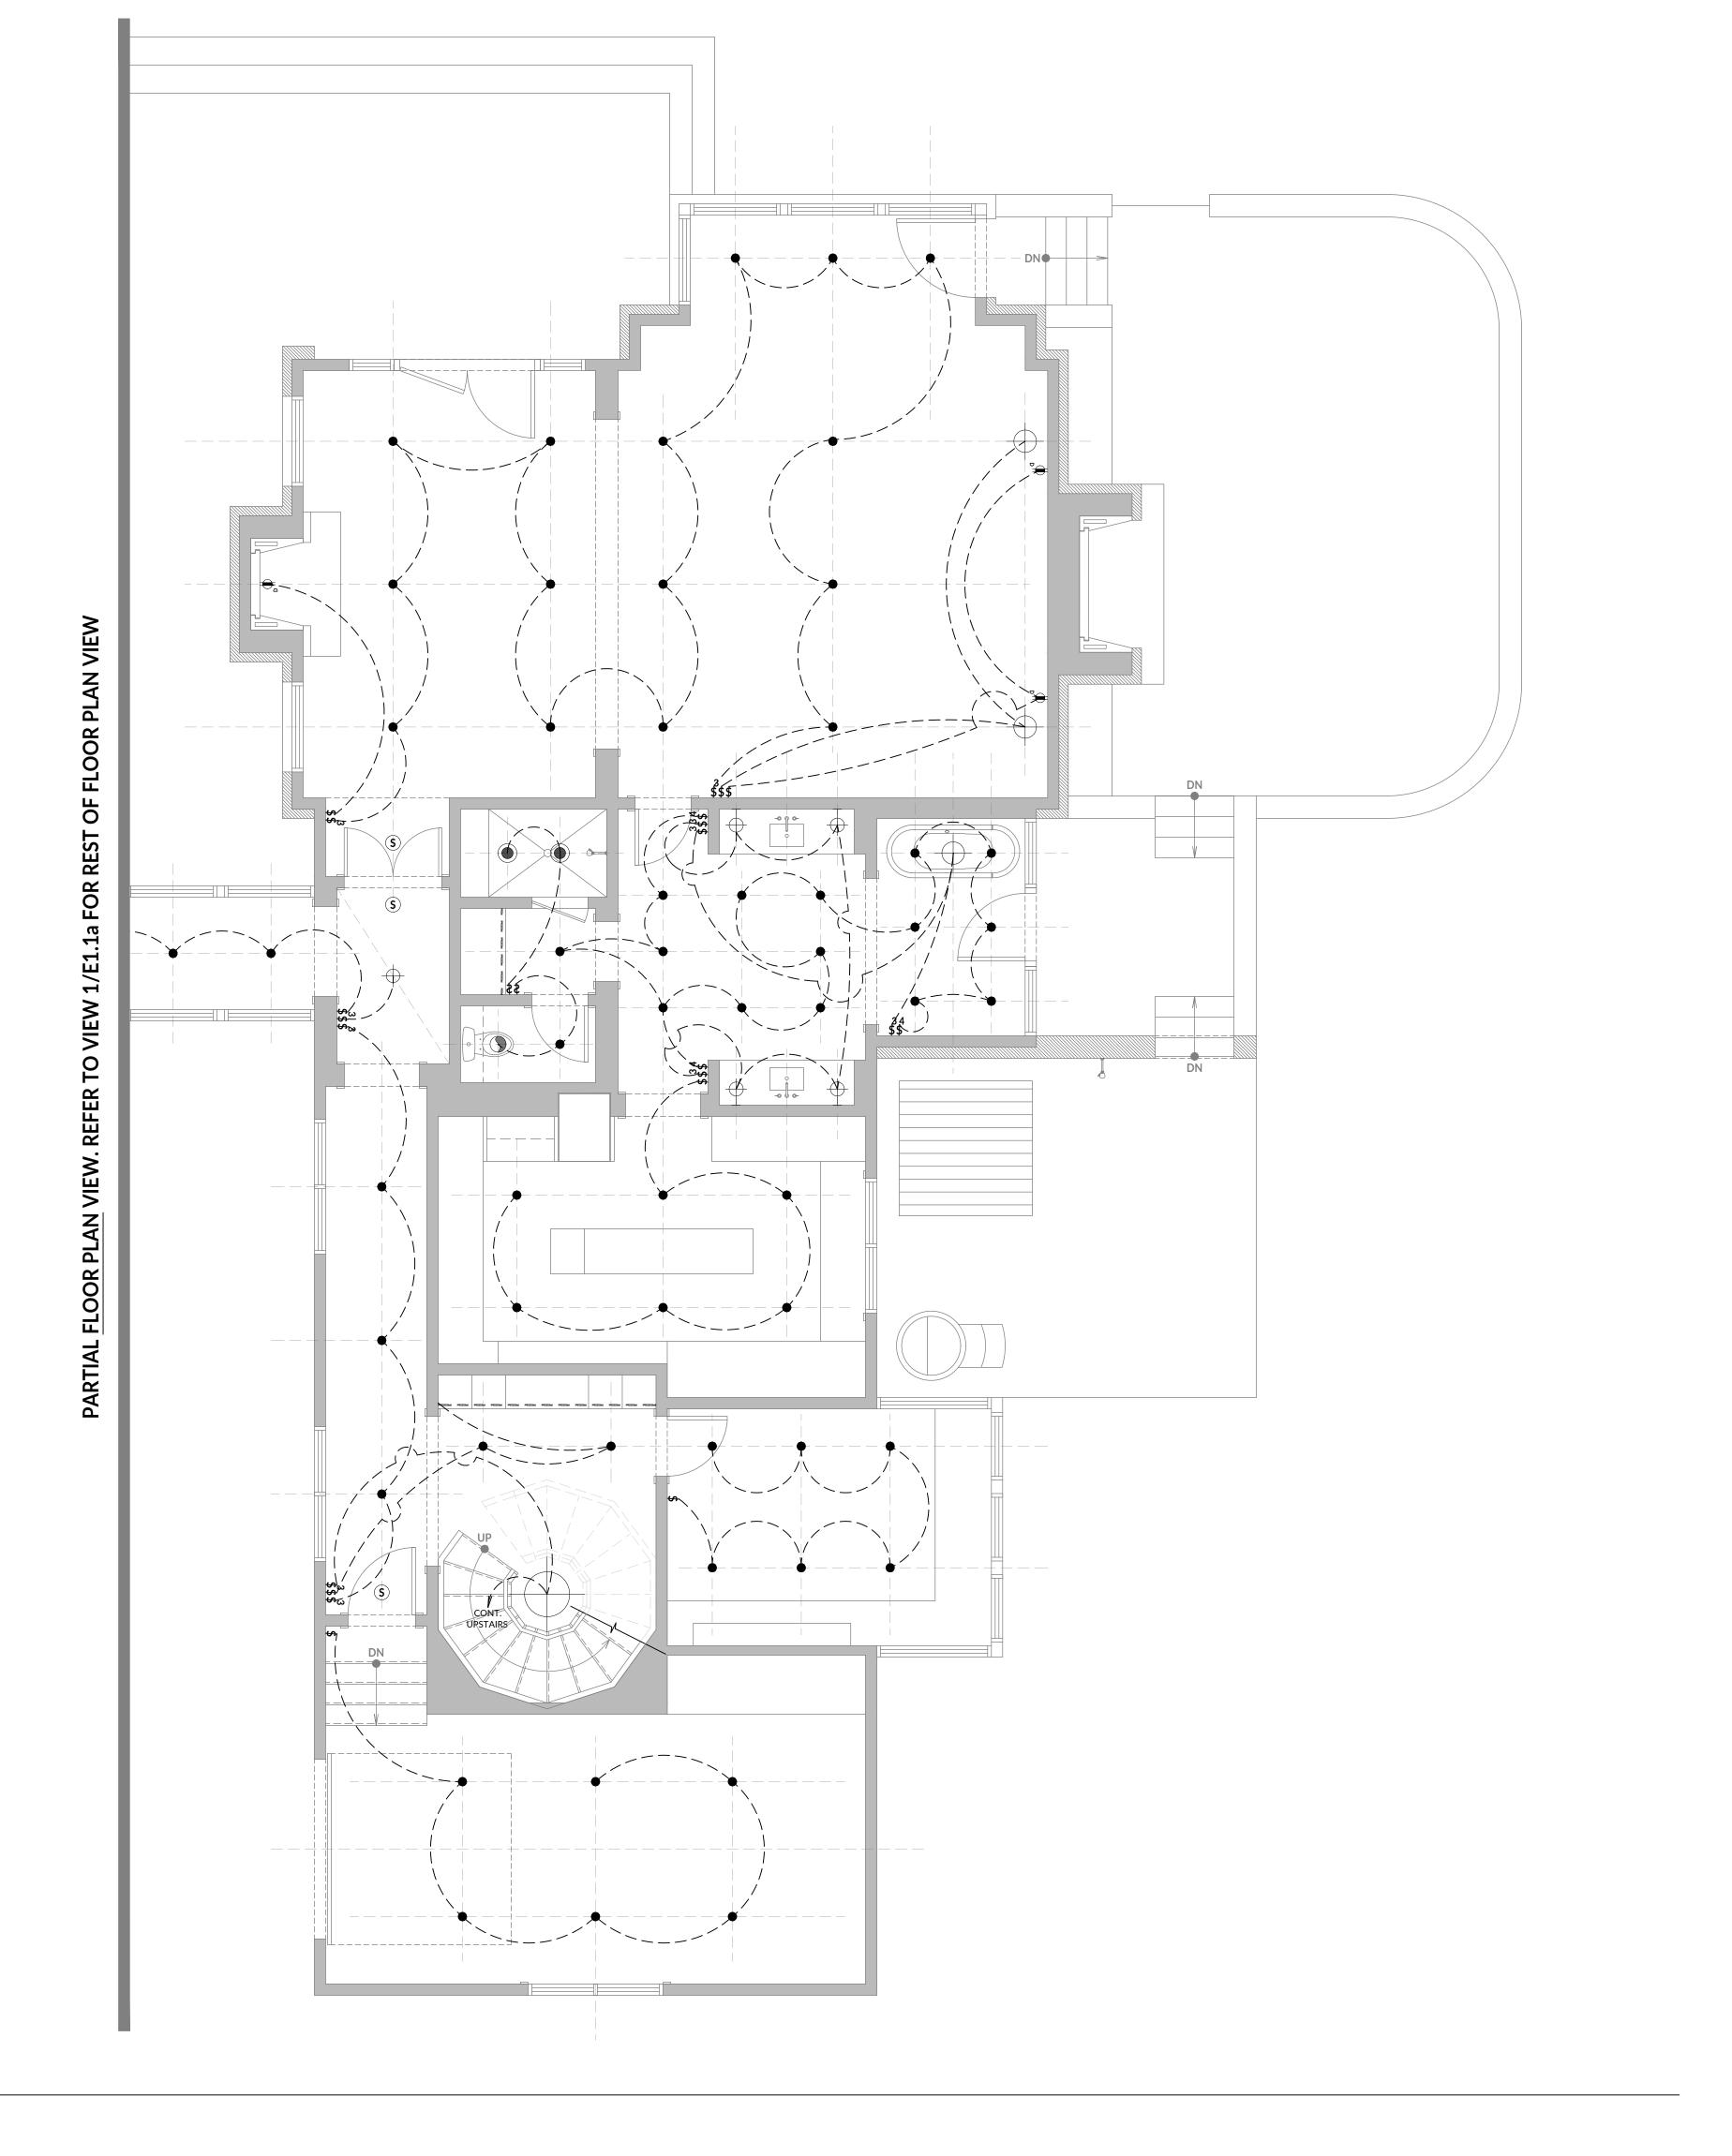

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ARCHITECT: MANOLO BANDA
ARCH. REG. NO.: 29491
Date: 5.1.2024

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DRAWN BY:

PROJECT NO:

PROJECT ISSUE DATE:

DRAWING TITLE


1ST FLOOR ELECTRICAL PLAN

24004

TBD

As indicated


DRAWING

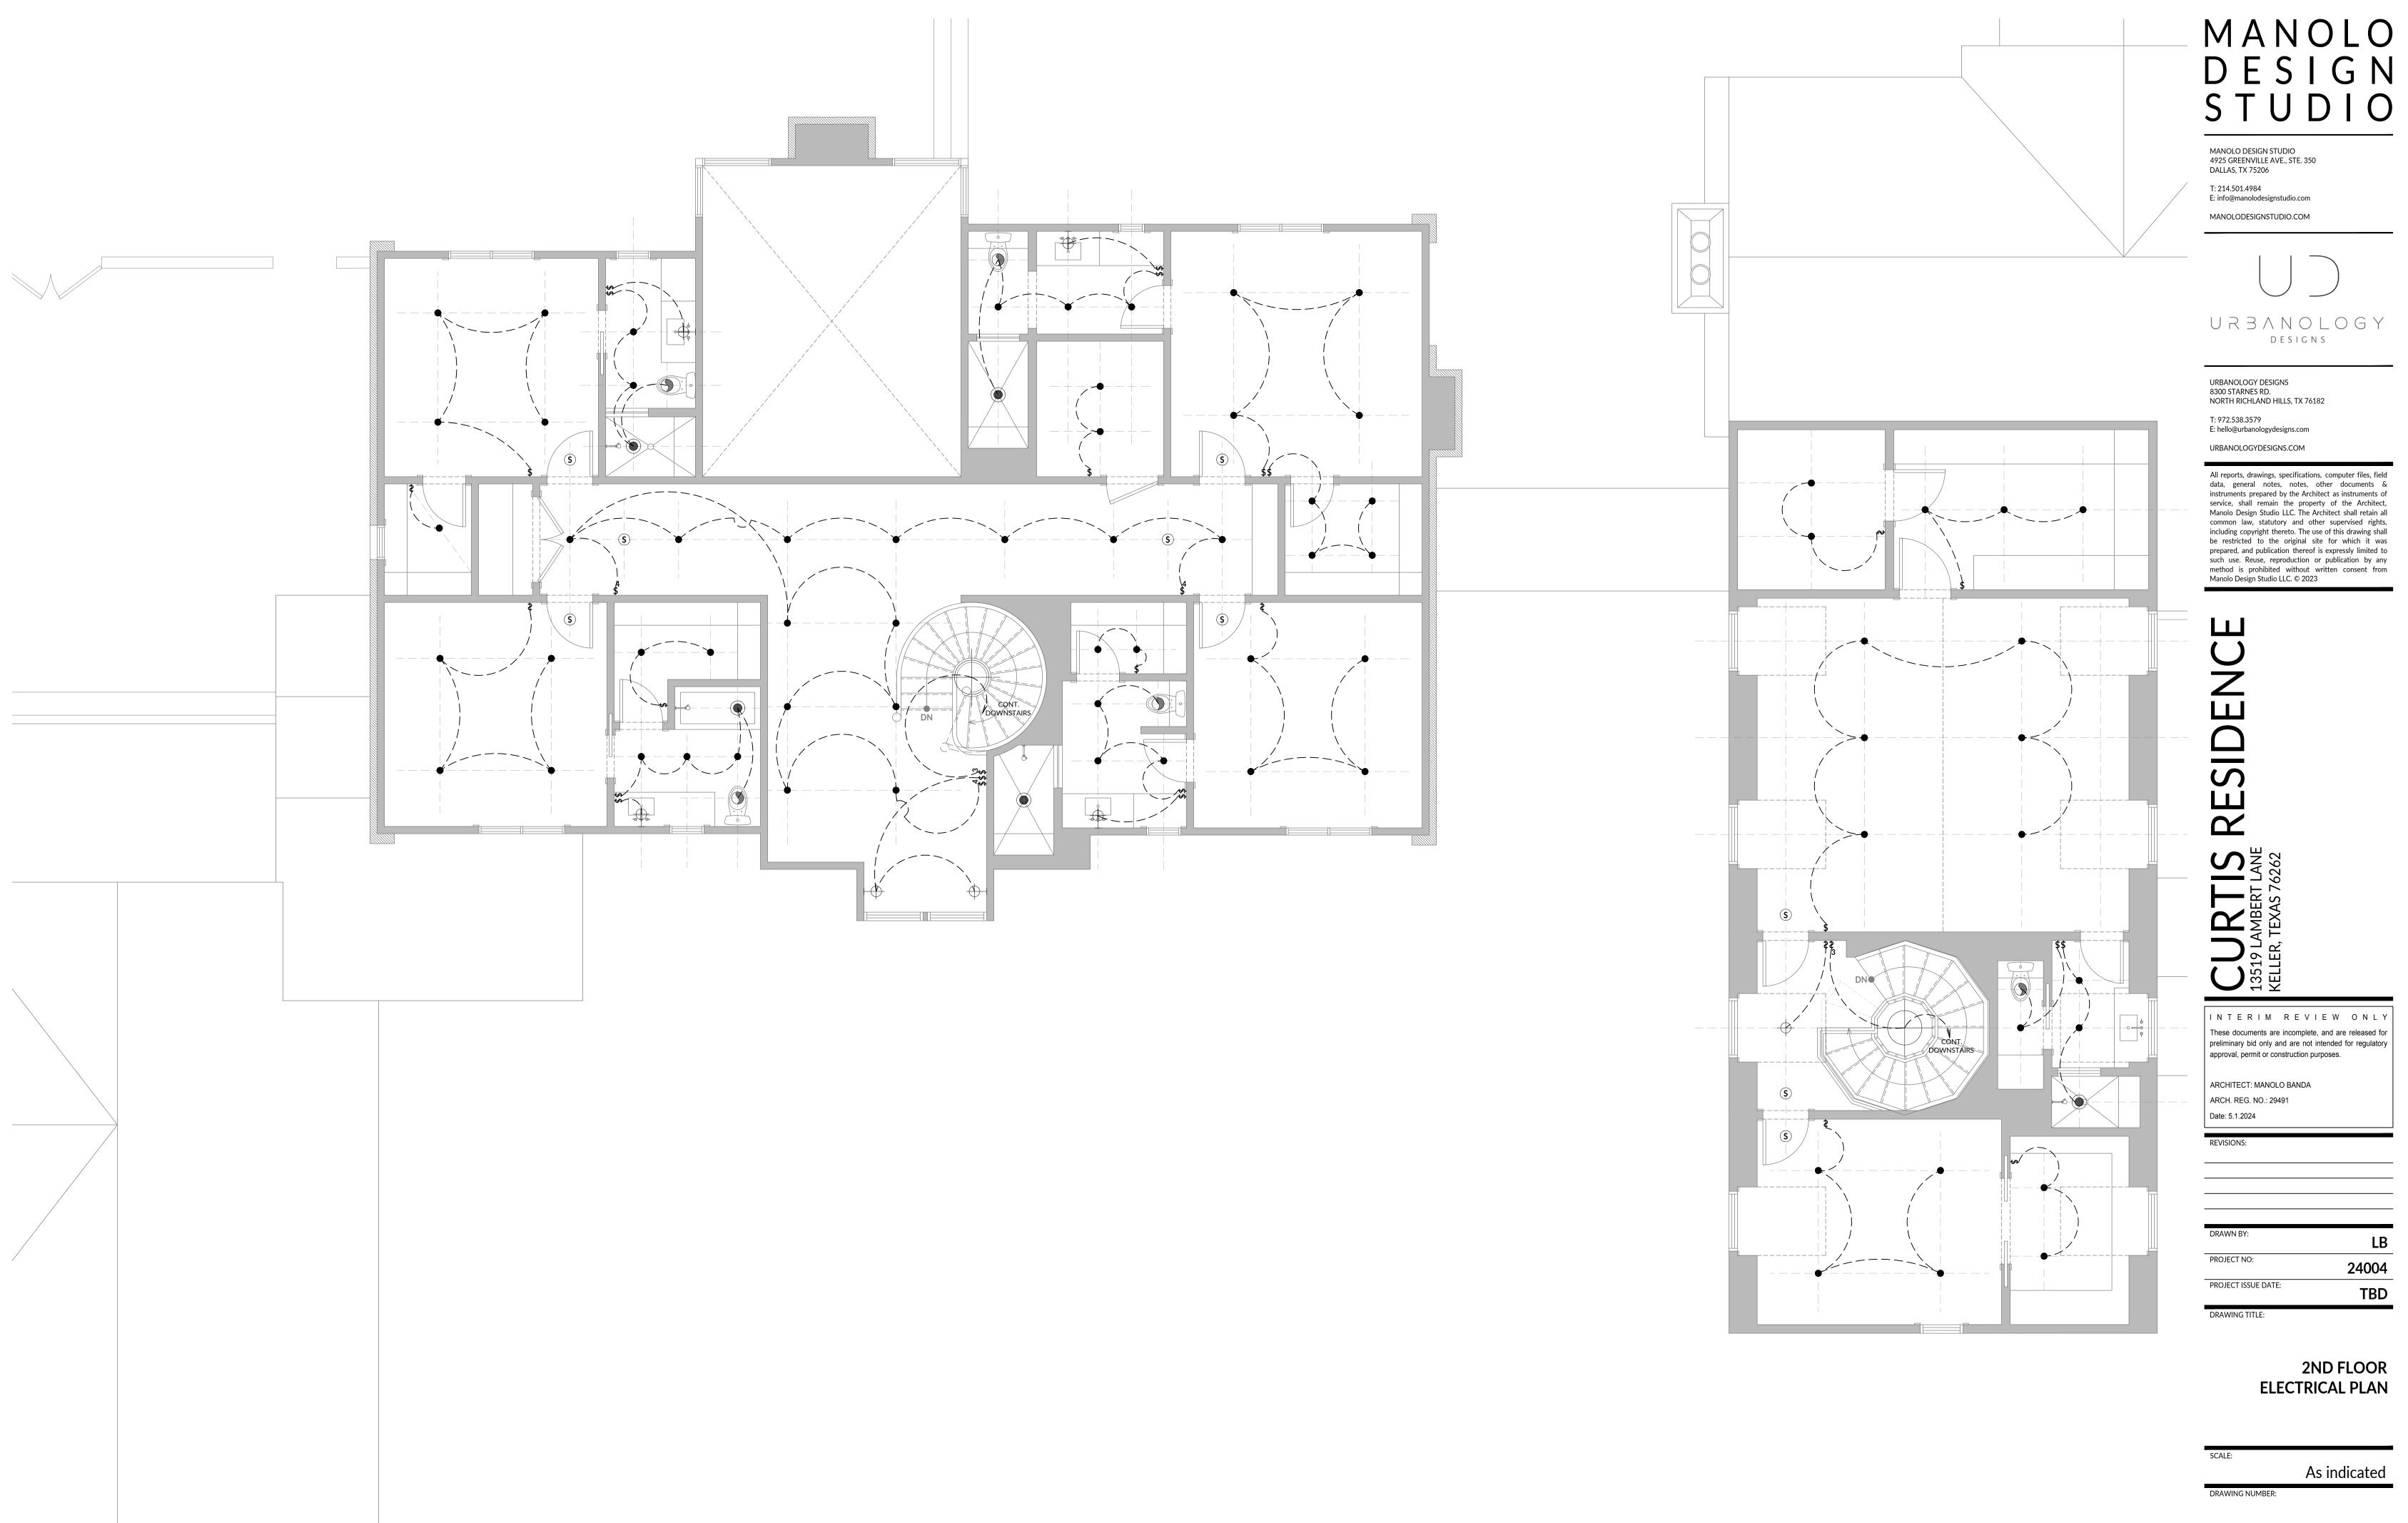

SECOND FLOOR PLAN - DIMENSIONS
SCALE: 0' - 1/4" = 1' - 0"

E1.2

8' 16'

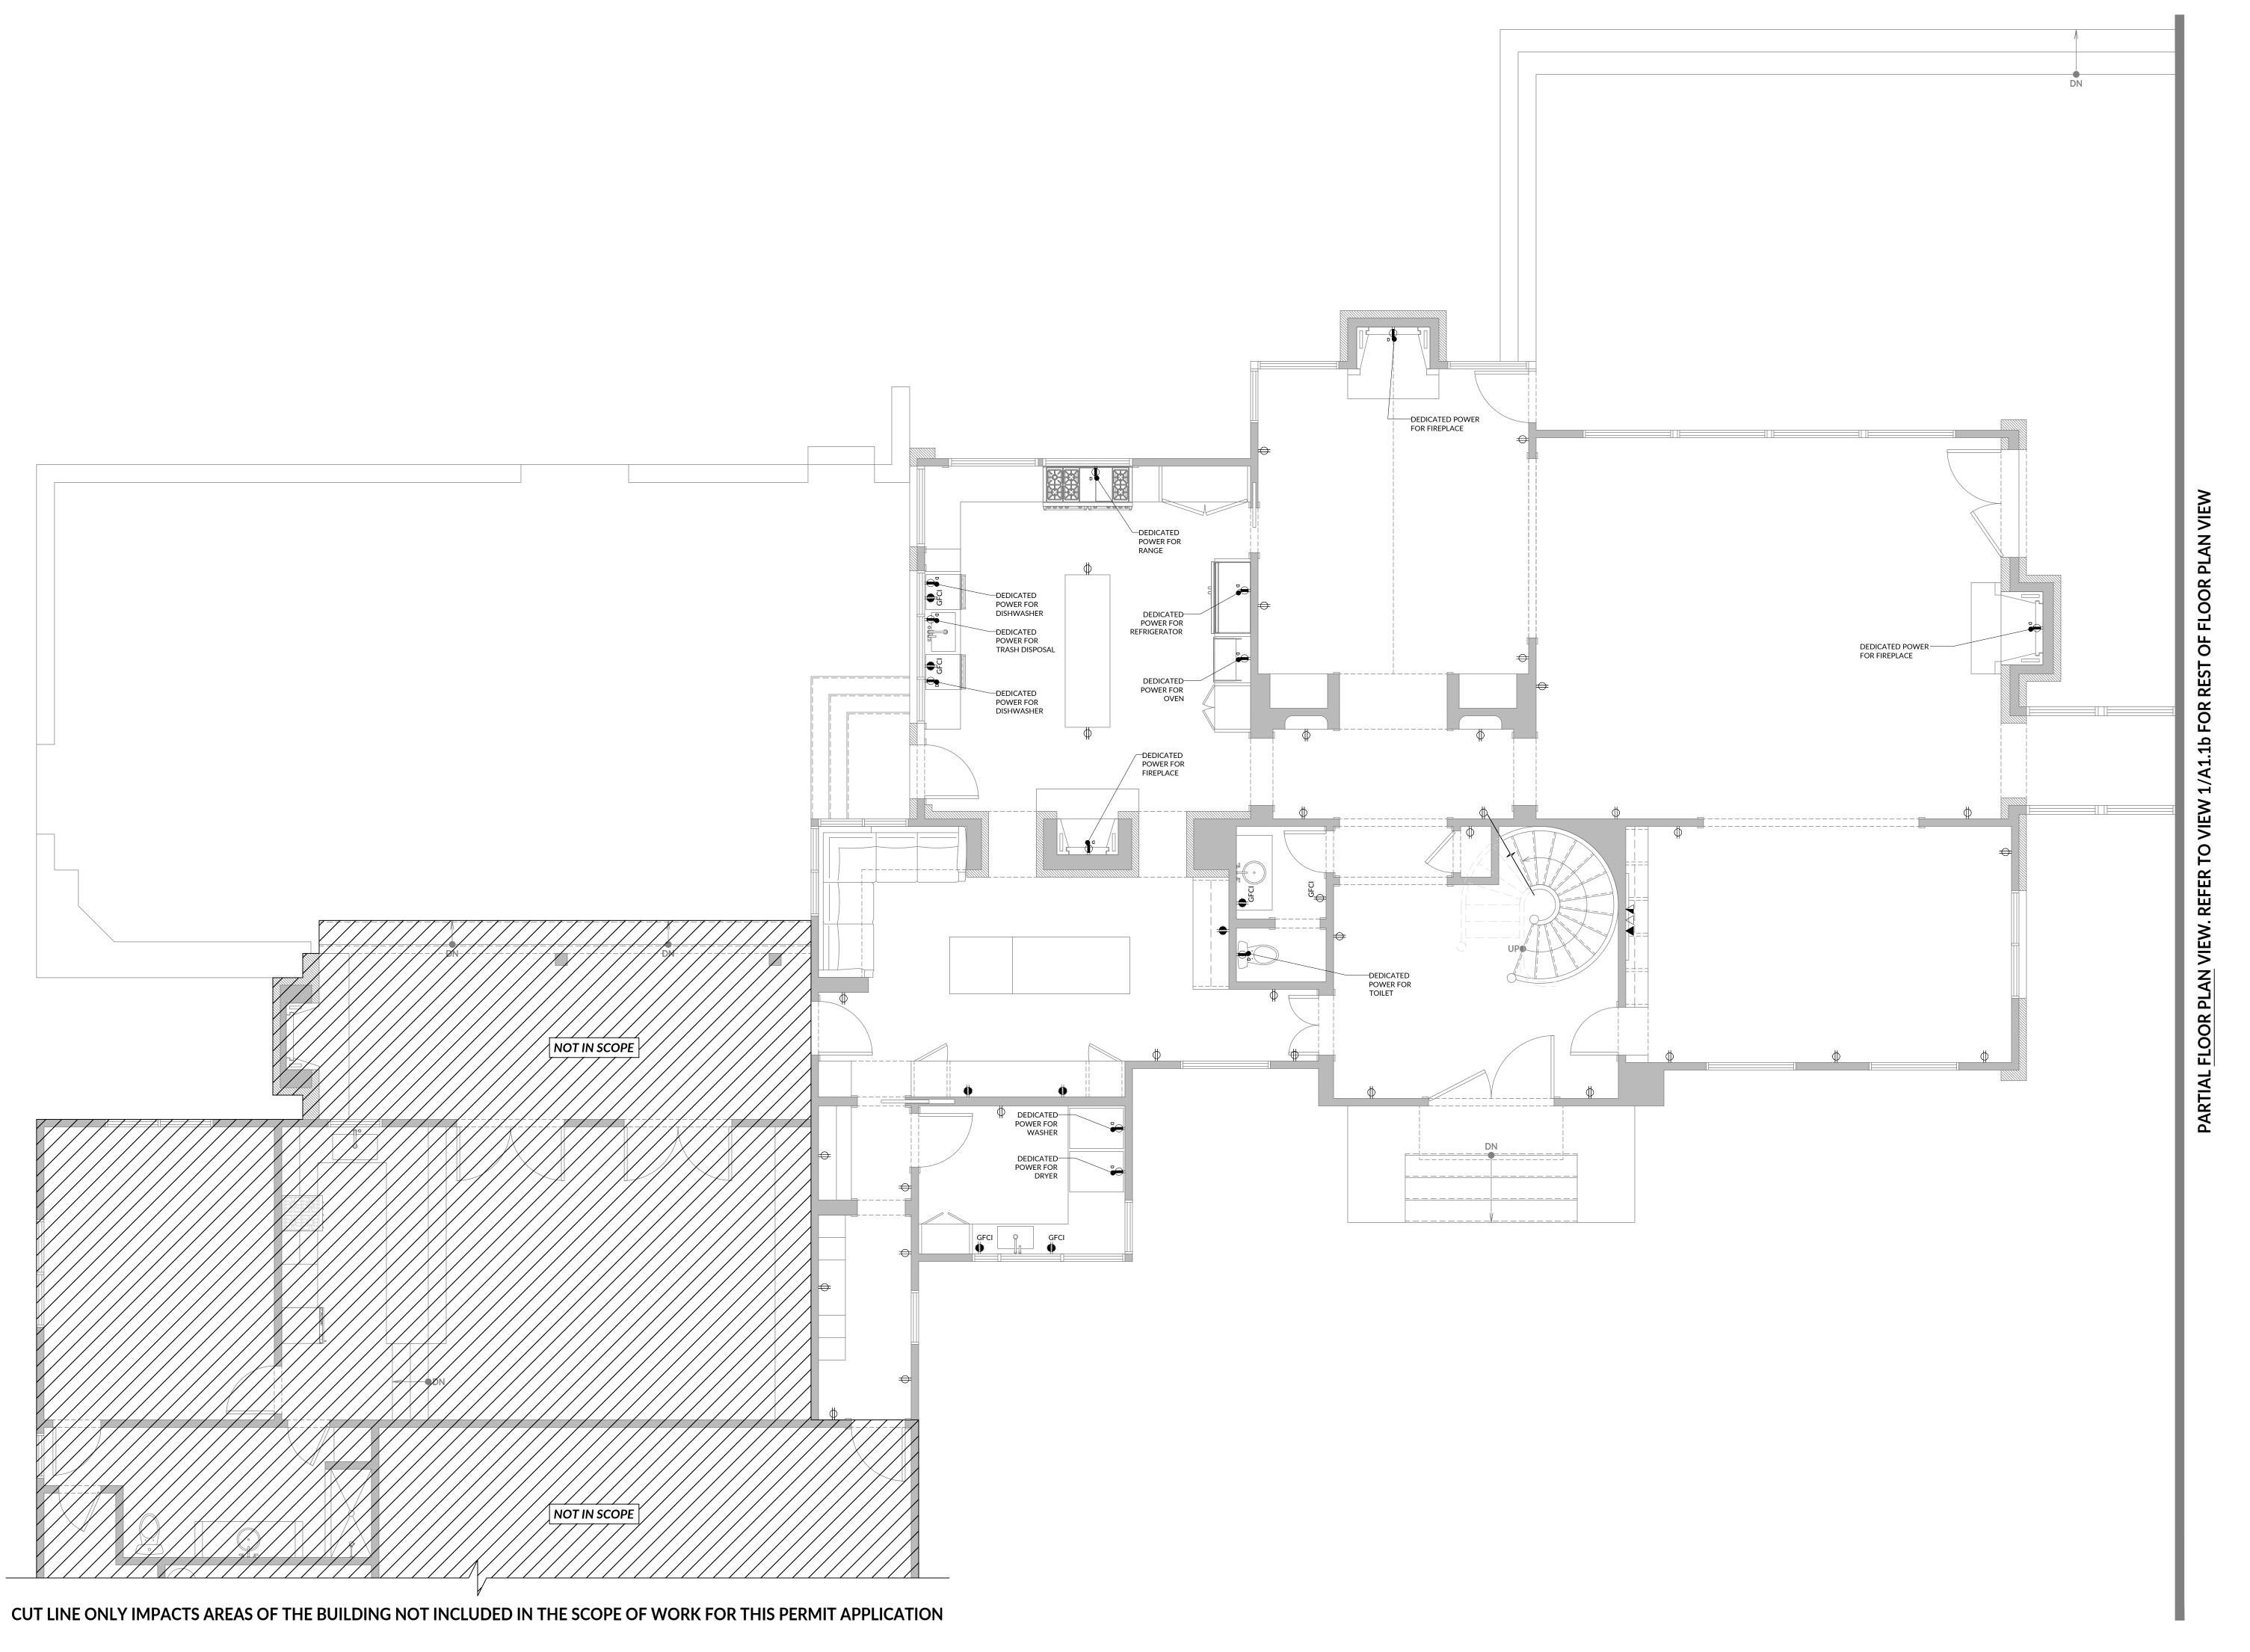

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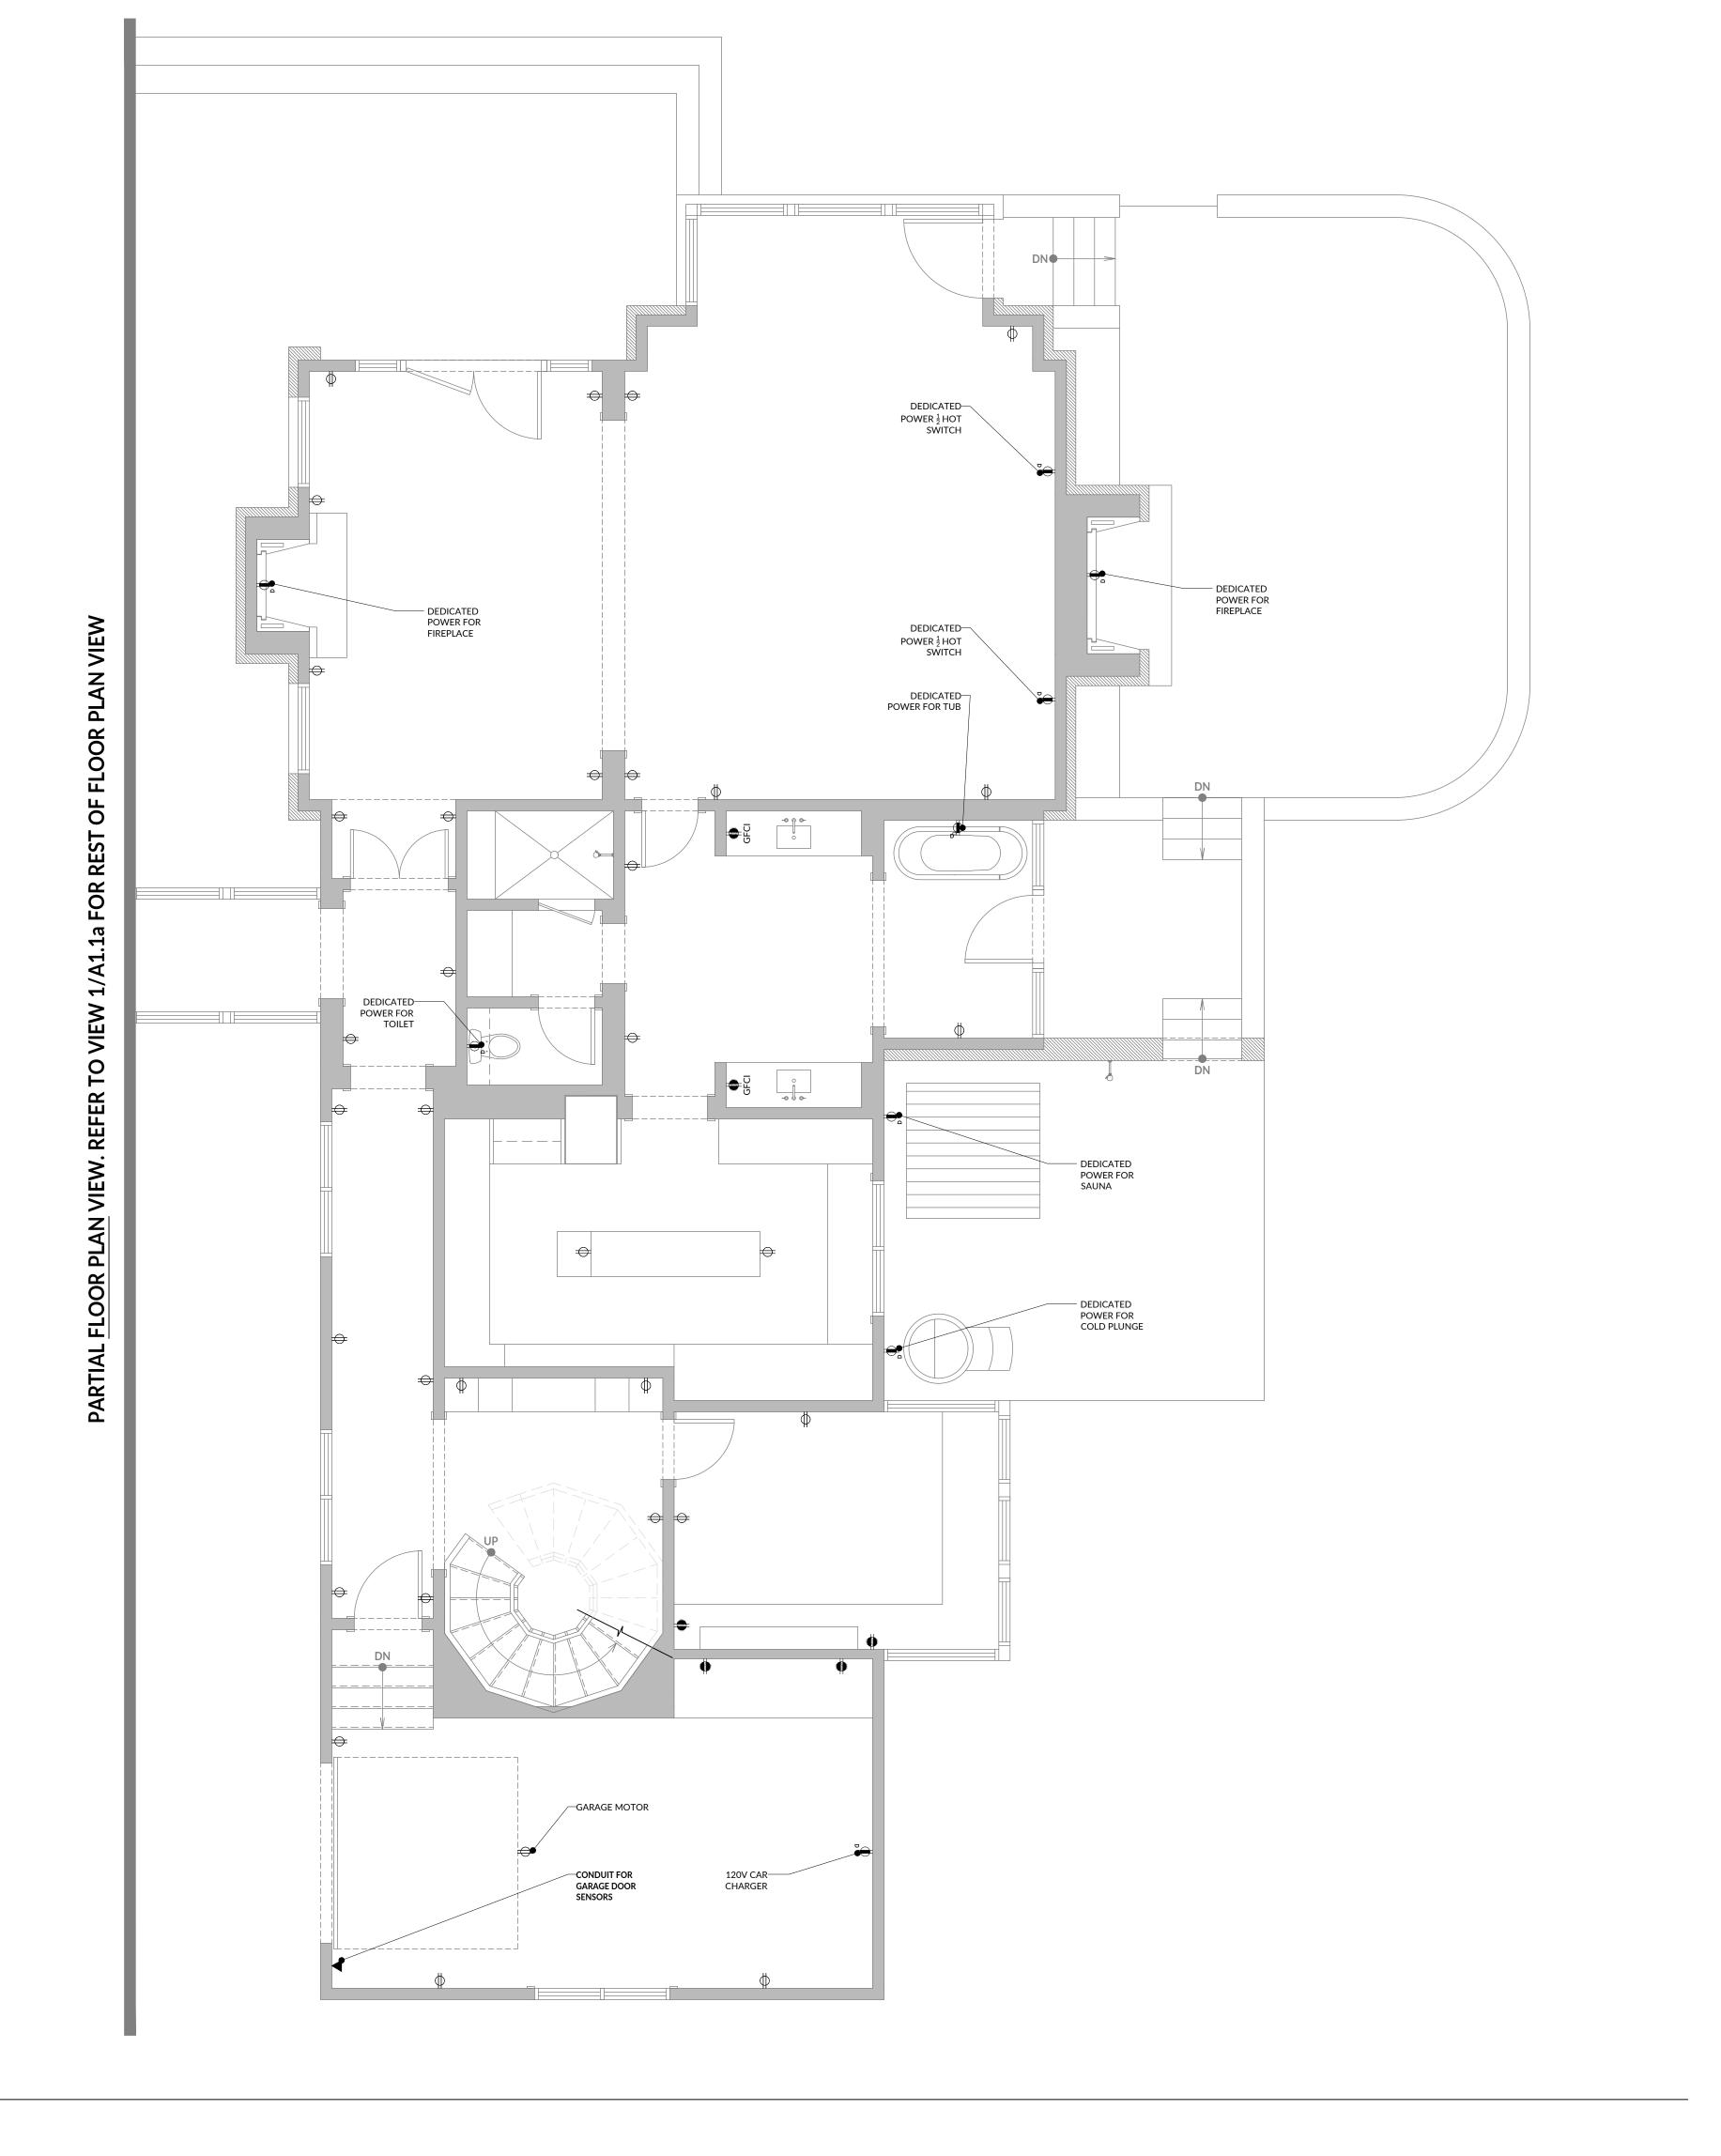
1ST FLOOR POWER PLAN

24004

TBD

As indicated

FIRST FLOOR PLAN - DIMENSIONS SCALE: 0' - 1/4" = 1' - 0"



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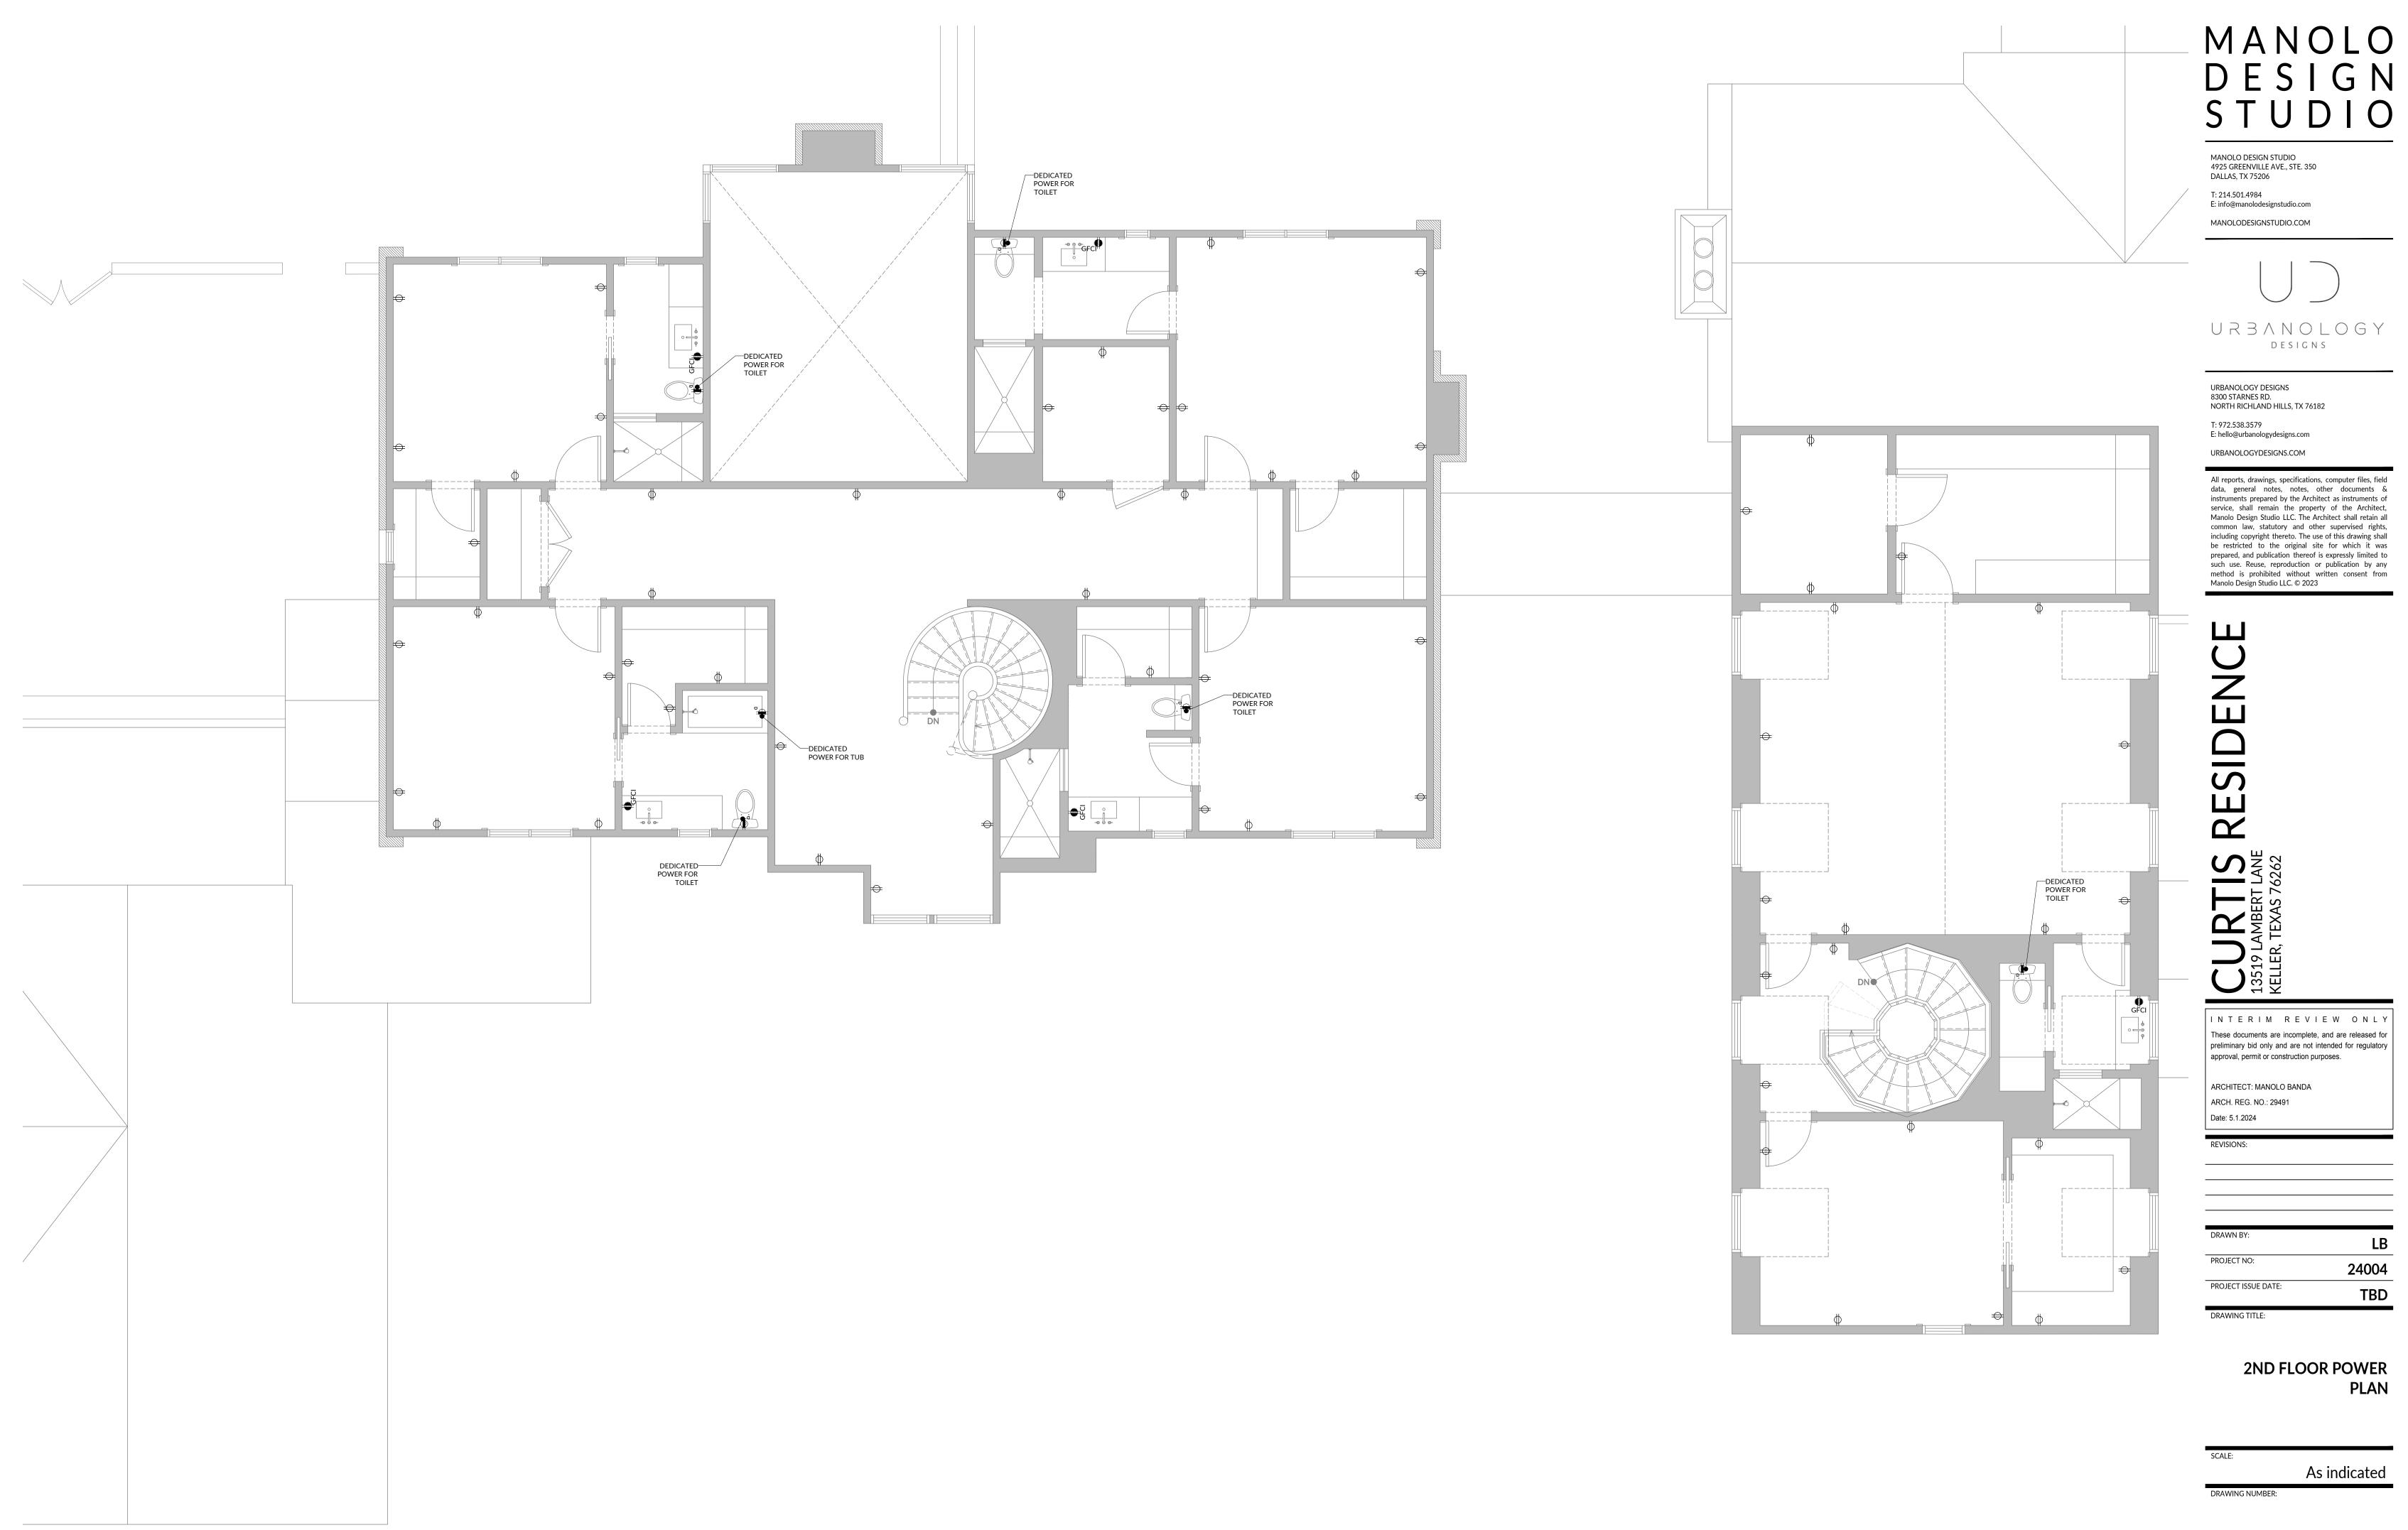
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1ST FLOOR POWER PLAN

TBD


As indicated

DRAWING NU



F1.4

8' 16'

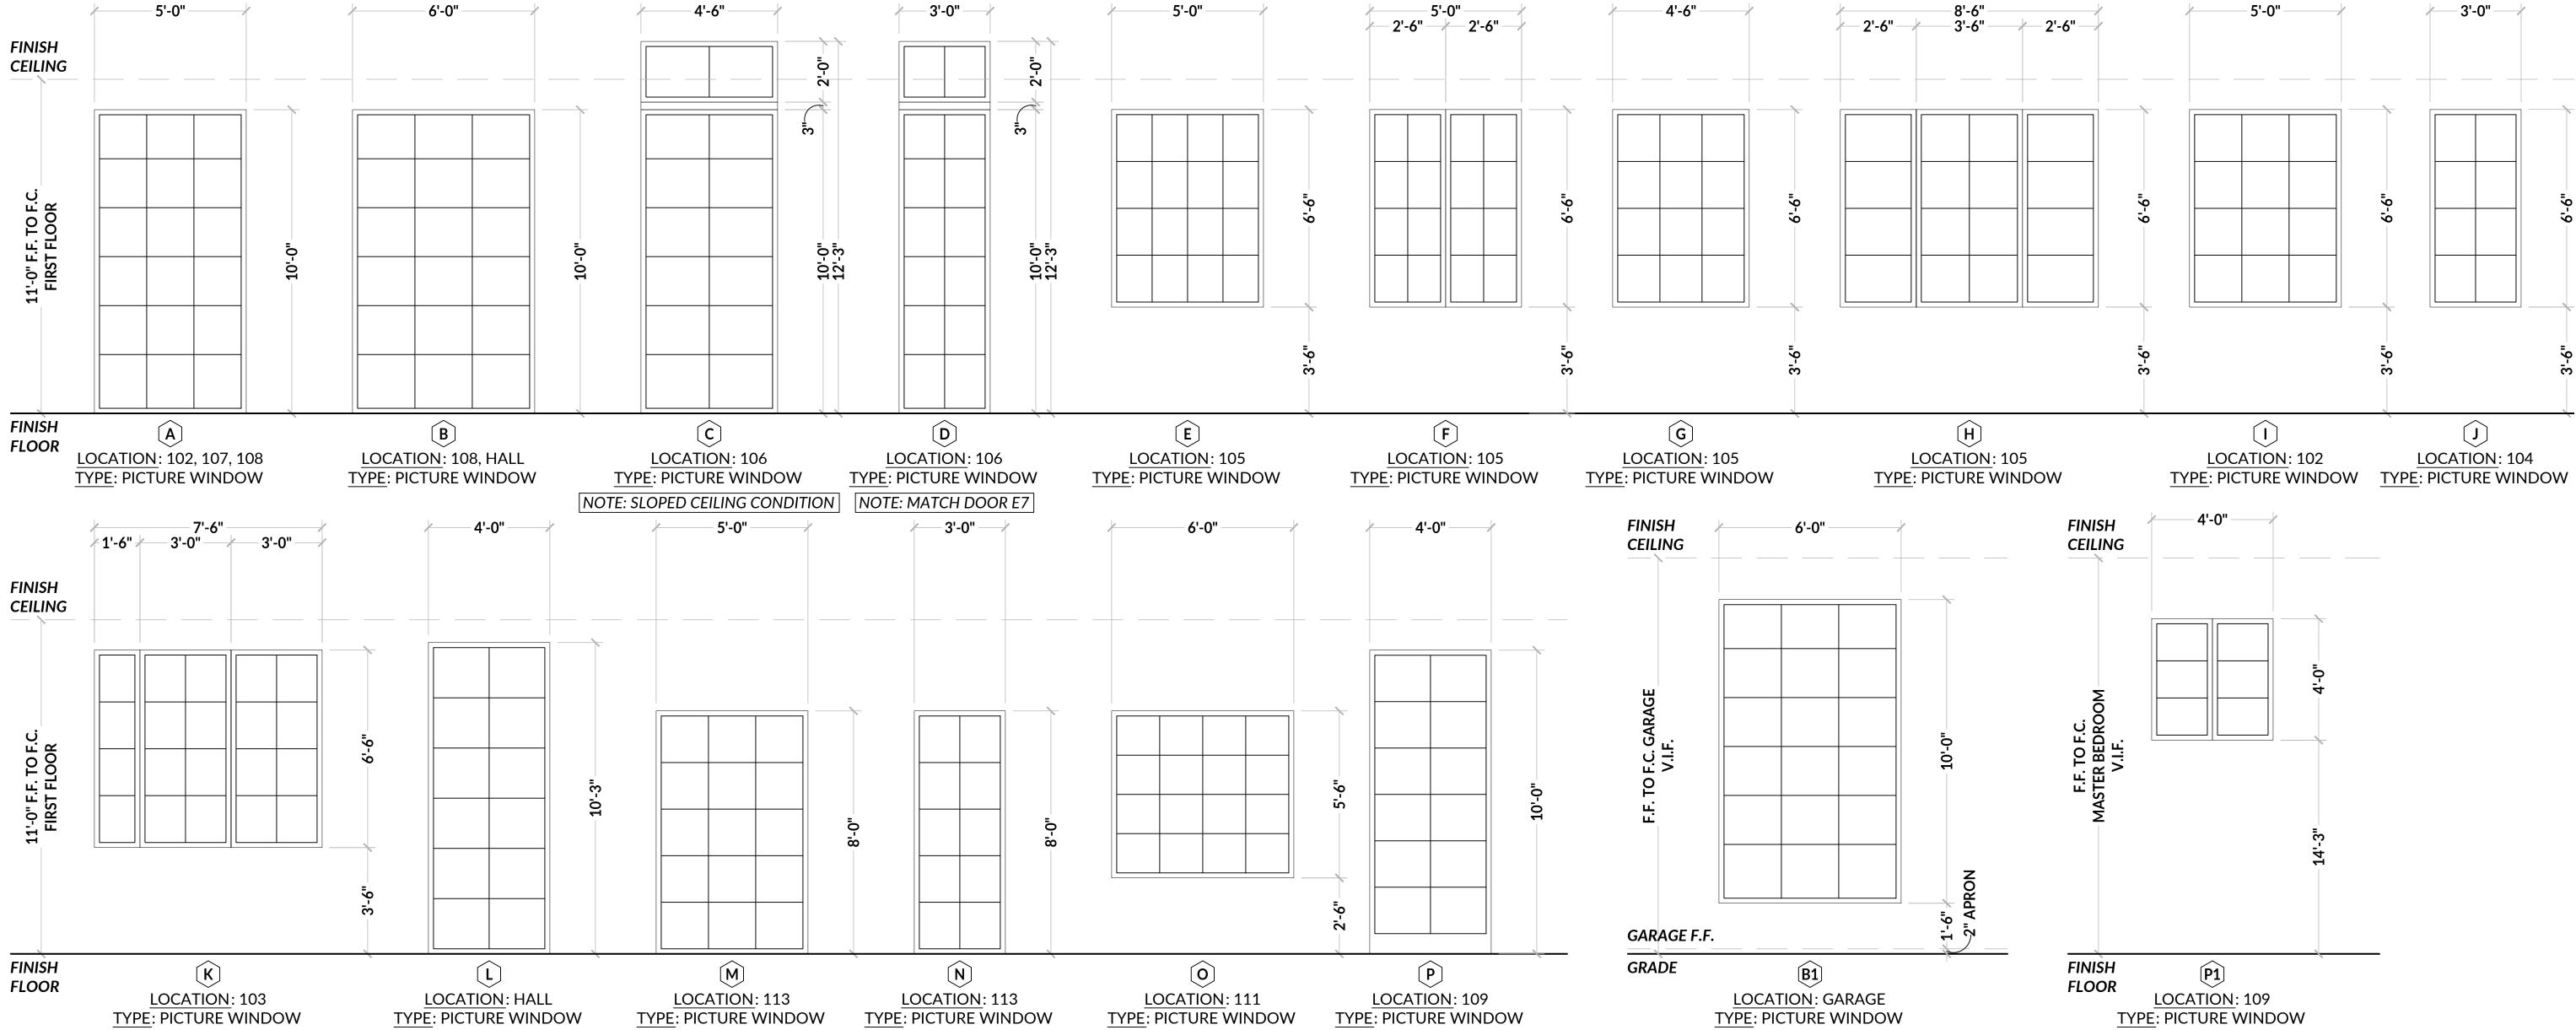

B WINDOW SCHEDULE, GENERAL INFORMATION & REQUIREMENTS SCALE: 0' - 3/8" = 1' - 0"

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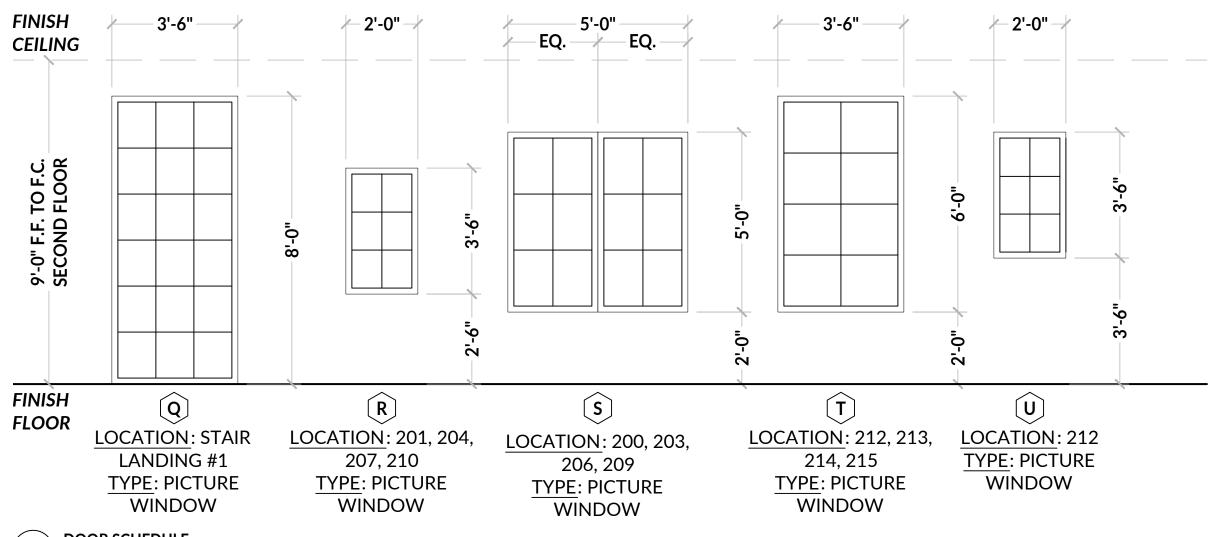
WINDOW & DOOR SCHEDULE


24004


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PROJECT NO:

PROJECT ISSUE DATE:

DRAWING TITLE

WINDOW & DOOR SCHEDULE

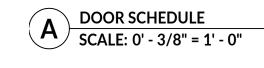24004

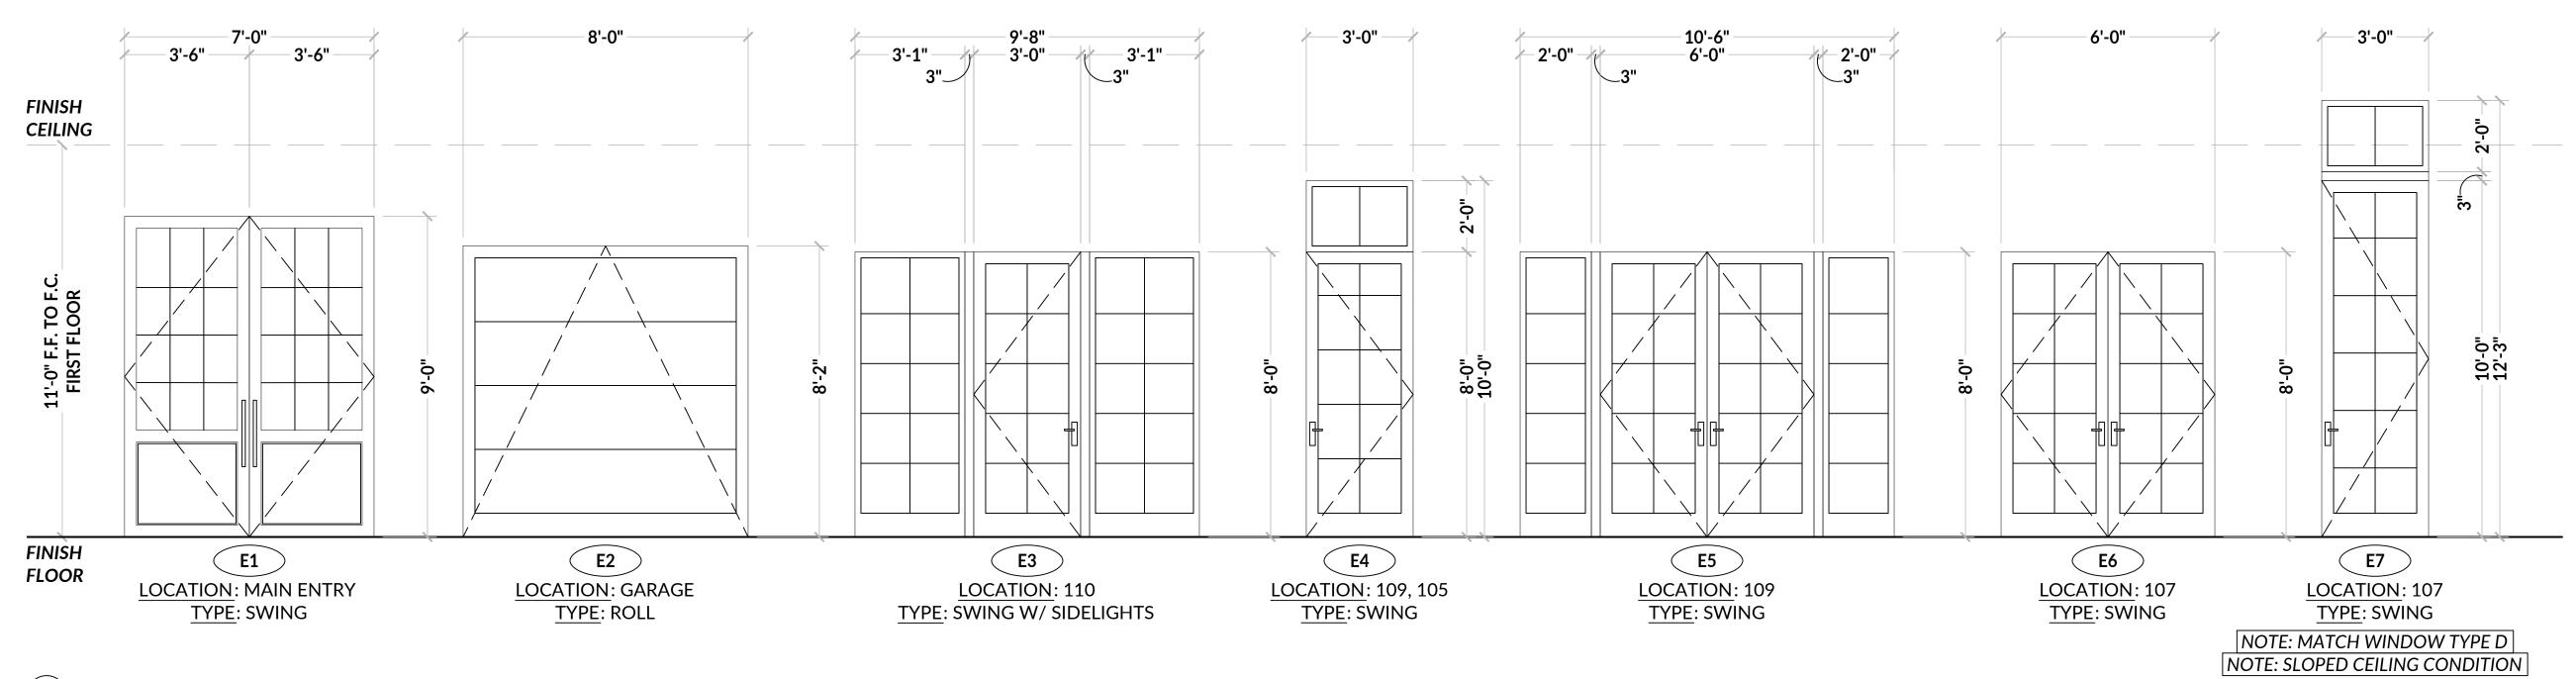TBD

SCALE:

As indicated

DRAWING NUMBER

A6.2